ABBREVIATIONS

AVERAGE **BEGIN CURVE BLIND FLANGE**

BUILDING **BENCH MARK**

BLOW OFF

BALL VALVE

CAST IRON

CENTERLINE

CLEANOUT

CONCRETE

COUPLING **CUBIC YARD** DETAIL DIAMETER DIMENSION **DRIVEWAY EXISTING** EACH **END CURVE ELEVATION**

EXISTING

CONSTRUCTION

CONTINUOUS

ASBESTOS CEMENT PIPE

AIR RELEASE VALVE

BUTTERFLY VALVE

BUREAU OF INDIAN AFFAIRS

COMBINATION AIR VALVE

CORRUGATED METAL PIPE

CATHODIC PROTECTION

EDGE OF PAVEMENT

EXISTING GROUND

FINISH FLOOR

FINISH GRADE

FINISH SURFACE

GALVANIZED GRADE BREAK GALLONS PER DAY GALLONS PER MINUTE

GATE VALVE HANDICAP

INCHES

LENGTH

MINIMUM

MANHOLE

MISCELLANEOUS

NOT APPLICABLE

NOT IN CONTRACT

OUTSIDE DIAMETER

POST INDICATOR VALVE

POINT OF CONNECTION

POLYVINYL CHLORIDE

RADIUS

REQUIRED

RIGHT OF WAY

SCHEDULE

SHEET

STATION

STEEL

STANDARD

SIDEWALK

TELEPHONE

THRUST BLOCK

TOP OF BANK

TOP OF CURB

TOP OF FOOTING

TOP OF PAVEMENT

VERTICAL CURVE

VICTAULIC COUPLING

COMMON TRENCH UTILITIES

TOP OF GRATE

TYPICAL

VARIES

VERTICAL WATER WIDE FLANGE

WATER LINE

WATER METER

WATER VALVE

WET WELL

WATER SERVICE

WELDED WIRE MESH

TOP WALL

STORM DRAIN

SPECIFICATIONS

SANITARY SEWER

RIGHT

RET WALL RETAINING WALL

POUND PER SQURE FOOT

POUND PER SQUARE INCH

REINFORCED CONCRETE

REINFORCED CONCRETE PIPE

SANITARY SEWER FORCE MAIN

NOT TO SCALE

NATIONAL GEODETIC VERTICAL DATUM

PORTLAND CEMENT CONCRETE

PRESSURE REGULATING VALVE

POTHOLE (UTILITY WAS POTHOLED)

MAX MIN

MISC

MH

N/A

NTS

OD

PH

PIV

POC

PSF

PSI

REQD

RT

R/W

STD

STL

TG

TYP

TW

UTL

VC

WL

WV

WWM

Know what's below.

Call before you dig.

VAR

VIC

VERT

JOINT POLE

LINEAR FEET LIGHT POLE LEFT METER MAXIMUM

INSIDE DIAMETER

JOINT UTILITY TRENCH

FLOW LINE FIRE LINE FLANGE

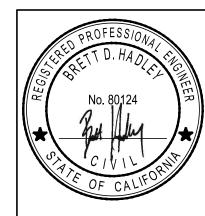
FLANGE COUPLING ADAPTOR

HIGH DENSITY POLYETHYLENE HYDRAULIC GRADE LINE

CABLE TELEVISION

AMERICAN INSTITUTE OF STEEL CONSTRUCTION

AIR AND VACUUM (COMBINATION) VALVE



7/9/2024 DATE SIGNED

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WATSONVILL EN INFRAS RE OF G CITY

DESIGNERS: BDH DRAWN BY: WES

DATE: 07/09/24 DRAWING NO. C-1.0

1 OF 19 SHEETS Attachment 3

Page 1 of 19

PROJECT PLANS FOR CONSTRUCTION OF RAMSAY PARK PHASE IV: GREEN INFRASTRUCTURE IMPROVEMENTS

IN THE CITY OF WATSONVILLE, CALIFORNIA



RELEVANT SPECIFICATIONS

SEE PHASE III SPECIFICATIONS. RELEVANT SPECIFICATION SECTIONS INCLUDE THE FOLLOWING:

DIVISION 1 - GENERAL REQUIREMENTS

01 10 00 SUMMARY

01 25 00 SUBSTITUTION PROCEDURES

01 26 00 CONTRACT MODIFICATION PROCEDURES

01 29 00 PAYMENT PROCEDURES

01 31 00 PROJECT MANAGEMENT AND COORDINATION

01 32 00 CONSTRUCTION PROGRESS DOCUMENTATION 01 32 00 CONSTRUCTION PROGRESS DOCUMENTATION - SUBMITTAL SCHEDULE FORM

01 33 00 SUBMITTAL PROCEDURES

01 33 40 DESIGN-BUILD DEFERRED SUBMITTAL PROCEDURES

01 40 00 QUALITY REQUIREMENTS

01 40 15 CONCRETE MOISTURE AND ALKALINITY TESTING 01 42 00 REFERENCES

01 45 29 TESTING LABORATORY SERVICES

01 45 50 TESTS AND INSPECTION SERVICES

01 50 00 TEMPORARY FACILITIES AND CONTROLS

01 56 39 TEMPORARY TREE AND PLANT PROTECTION

01 57 23 STORM WATER POLLUTION PREVENTION PLAN 01 64 00 OWNER FURNISHED ITEMS

01 73 29 CUTTING AND PATCHING

01 77 00 CLOSEOUT PROCEDURES

01 77 00_ CLOSEOUT PROCEDURES - PUNCH LIST FORM

01 78 40 PROJECT AS-BUILT DOCUMENTS

01 78 40_PROJECT AS-BUILT DOCUMENTS - AS-BUILT PRODUCT DATA FORM

DIVISION 2 - EXISTING CONDITIONS

02 20 00 EARTHWORK 02 23 00 SITE CLEARING

02 41 13 SITE CLEARING AND DEMOLITION

DIVISION 3 - CONCRETE

03 05 10 CONCRETE COLOR ADDITIVE 03 10 00 CONCRETE FORMING AND ACCESSORIES

03 20 00 CONCRETE REINFORCEMENT

03 30 00 CAST-IN-PLACE CONCRETE

03 35 00 CONCRETE SEALERS 03 53 00 CONCRETE TOPPING

DIVISION 5 - METALS 05 52 00 METAL RAILINGS

DIVISION 26 - ELECTRICAL

26 05 00 GENERAL ELECTRICAL REQUIREMENTS

26 05 19 CABLES

26 05 26 GROUNDING

25 05 42 CONDUITS

DIVISION 31 - EARTHWORK 31 01 90 LANDSCAPE AND SITE MAINTENANCE

31 20 00 EARTH MOVING

31 23 00 EXCAVATION AND FILL

DIVISION 32 - EXTERIOR IMPROVEMENTS 32 01 90 EXISTING TREE PROTECTION AND MAINTENANCE

32 11 00 BASE COURSES

32 13 13 CONCRETE PAVING 32 14 43 PERMEABLE PAVERS

32 32 15 LANDSCAPE CONCRETE

32 33 00 SITE FURNISHINGS

32 80 00 IRRIGATION 32 90 00 PLANTING

DIVISION 33 - UTILITIES

33 40 00 STORM DRAINAGE UTILITIES

Sheet Fist Table						
	Sheet Number	Sheet Title				
	C-1.0	TITLE SHEET				
	C-1.1	NOTES SHEET				
	C-1.2	OVERALL SITE PLAN				
	C-2.0	GRADING AND DRAINAGE PLAN				
	C-3.0	EROSION CONTROL PLAN				
	C-3.1 EROSION CONTROL PLAN DETAILS					
	C-4.0	CONSTRUCTION DETAILS				
	LL-1	SLOPE SITE PLAN				
	LL-2	GREEN ROOF SITE PLAN				
	LD-1	SITE DETAILS & NOTES				
	LD-2	SITE DETAILS				
	LD-3	SITE DETAIL				
	PL-1	SLOPE PLANTING PLAN				
	PL-2	GREEN ROOF PLANTING PLAN				
	PD-1	PLANTING DETAILS & NOTES				
	IL-1	SLOPE IRRIGATION PLAN & NOTES				
	IL-2	GREEN ROOF IRRIGATION PLAN				
	ID-1	IRRIGATION DETAILS				

ELECTRICAL PLAN

Sheet List Table

FOR REDUCED PLANS ORIGINAL SCALE IS IN INCHES FILE NAME: 1535-0007-TITL.DWG Plot Date: 7/9/2024

GENERAL NOTES

- 1. THESE PLANS ARE PART OF A SET OF CONTRACT DOCUMENTS AND SHALL NOT BE CONSIDERED THE SOLE SOURCE OF CONSTRUCTION INFORMATION. ALL CONSTRUCTION WORK AND INSTALLATIONS SHALL CONFORM TO THE CITY OF WATSONVILLE STANDARDS AND SPECIFICATIONS, THE CONTRACT DOCUMENTS AND WORK SHALL BE SUBJECT TO THE APPROVAL OF THE PUBLIC WORKS DEPARTMENT.
- 2. THE CONTRACTOR SHALL HAVE COPIES OF THE APPROVED CONTRACT DOCUMENTS FOR THIS PROJECT ON THE SITE AT ALL TIMES AND SHALL BE FAMILIAR WITH ALL APPLICABLE STANDARDS AND SPECIFICATIONS.
- 3. CONTRACTOR AGREES THAT HE SHALL ASSUME SOLE AND COMPLETE RESPONSIBILITY FOR THE JOB SITE DURING THE COURSE OF THE PROJECT, INCLUDING SAFETY OF ALL PERSONS AND PROPERTY; THAT THIS REQUIREMENT SHALL APPLY CONTINUOUSLY AND NOT BE LIMITED TO NORMAL WORKING HOURS; AND THAT THE CONTRACTOR SHALL DEFEND, INDEMNIFY, AND HOLD THE ENGINEER AND OWNER HARMLESS FROM ANY AND ALL LIABILITY, REAL OR ALLEGED, IN CONNECTION WITH THE PERFORMANCE OF WORK ON THIS PROJECT, EXCEPTING FOR LIABILITY ARISING FROM THE SOLE NEGLIGENCE OF THE OWNER OR ENGINEER, OR THIRD PARTY IN VIOLATION OF THE LAW OR IN TRESPASS. THE CONTRACTOR SHALL PRACTICE SAFETY AT ALL TIMES AND SHALL FURNISH, ERECT, AND MAINTAIN, SUCH FENCES, BARRICADES, LIGHTS, AND SIGNS NECESSARY TO GIVE ADEQUATE PROTECTION TO THE PUBLIC AT ALL TIMES.
- 4. INFORMATION PERTAINING TO EXISTING UNDERGROUND FACILITIES IS BASED ON RECORD INFORMATION AND IS SHOWN FOR INFORMATION PURPOSES ONLY. UNDERGROUND FEATURES SHOWN IN PLAN VIEW ON THE PLANS ARE INDICATED WITH THEIR APPROXIMATE LOCATION AND EXTENT, AND MAY NOT APPEAR IN PROFILE OR SECTIONS VIEWS. THE CONTRACTOR SHALL BE RESPONSIBLE FOR CONTACTING ALL AGENCIES INVOLVED AND SHALL LOCATE ALL FACILITIES PRIOR TO EXCAVATION IN ANY AREA. THE CONTRACTOR SHALL CALL UNDERGROUND SERVICE ALERT (USA), TOLL FREE AT 811, THE CITY OF WATSONVILLE PRIOR TO THE START OF CONSTRUCTION.
- 5. THE CONTRACTOR SHALL CONTINUALLY REVIEW JOB SITE CONDITIONS. CONDITIONS REQUIRING CONSTRUCTION DIFFERENT FROM THAT SHOWN ON THE PLANS SHALL BE REPORTED TO THE ENGINEER PRIOR TO PROCEEDING WITH THE AFFECTED CONSTRUCTION.
- 6. THESE DRAWINGS REPRESENT THE FINISHED CONDITION AND UNLESS OTHERWISE INDICATED, THEY DO NOT SHOW THE METHOD OF CONSTRUCTION.
- 7. ALL IMPROVEMENTS SHOWN OR INDICATED ON THESE DRAWINGS ARE TO BE CONSTRUCTED AND/OR INSTALLED BY THE CONTRACTOR IN THIS PROJECT, UNLESS THEY ARE CALLED OUT AS: "EXISTING", "FUTURE", "NIC", NOT A PART; OR HAVE SOME OTHER EXCLUDING NOTATION.
- 8. CONTRACTOR SHALL KEEP A SET OF PROJECT DRAWINGS ON WHICH RECORD INFORMATION SHALL BE PLACED NOTING DEVIATIONS FROM THE PLANS IN THE LOCATION, GRADE, SIZE, TYPE, AND SCOPE OF WORK WHICH IS CONSTRUCTED.
- 9. THE ENGINEER OF WORK SHALL PERFORM PERIODIC REVIEWS OF COMPLETED WORK TO DETERMINE CONFORMANCE WITH THE APPROVED PLANS. CONTRACTOR SHALL CORRECT ANY DIFFERENCES FOUND BY SUCH SURVEY AND WILL PROVIDE ALL CONTRACTOR'S RECORDS KEPT DURING THE COURSE OF CONSTRUCTION TO THE ENGINEER OF WORK FOR PREPARATION OF RECORD DRAWINGS. ENGINEER WILL PREPARE SUCH RECORD DRAWINGS UPON COMPLETION OF THE WORK AND PRIOR TO CITY'S FINAL INSPECTION.
- 10. OCCUPATIONAL SAFETY AND HEALTH ACT (OSHA) REQUIREMENTS AND STANDARDS SHALL BE OBSERVED AT THE JOB SITE AT ALL TIMES.
- 11. ALL CONSTRUCTION SHALL BE IN COMPLETE COMPLIANCE WITH ALL RECOMMENDATIONS AND REQUIREMENTS AS SET FORTH IN THE SOILS REPORT: RAMSAY PARK IMPROVEMENTS, PACIFIC CREST ENGINEERING INC., DATED JANUARY 2020.
- 12. DRY UTILITY LINES ARE SHOWN FOR REFERENCE ONLY. CONTACT PROJECT OWNER FOR UTILITY COMPANY PLANS.
- 13. PRIOR TO FINAL INSPECTION AND/OR CERTIFICATION OF OCCUPANCY THE COUNTY HEALTH DEPT SHALL APPROVE & INSPECT THE CROSS CONNECTION DEVICES
- 14. CONTRACTOR TO WORK WITHIN THE FOLLOWING CONSTRUCTION HOURS: MONDAY - FRIDAY 7:00am - 6:00pm SATURDAY 8:00am - 5:00pm NO WORK ALLOWED SUNDAY

PRE-CONSTRUCTION MEETING

1. A PRE-CONSTRUCTION MEETING SHALL BE HELD PRIOR TO COMMENCEMENT OF WORK. THE MEETING SHALL INCLUDE (AT A MINIMUM) THE OWNER/REPRESENTATIVE, CONTRACTORS, ENGINEER OF WORK, SOILS ENGINEER, PERTINENT UTILITY COMPANIES, SURVEYOR AND CITY STAFF.

CONSTRUCTION NOTES

- 1. THE CONTRACTOR SHALL INVESTIGATE THE SITE DURING CLEARING AND EARTHWORK OPERATIONS FOR ANY EXISTING HAZARD TO CONSTRUCTION NOT SHOWN ON THE PLANS SUCH AS FILLED EXCAVATIONS OR BURIED STRUCTURES SUCH AS CESSPOOLS, CISTERNS, FOUNDATIONS, OR LARGE DEPOSITS OF ORGANIC MATERIAL, ETC. IF ANY SUCH HAZARDS ARE FOUND, THE OWNER AND ENGINEER SHALL BE NOTIFIED. ALL EXISTING SURFACE STRUCTURES, FENCES, TANKS, PIPES, ETC., AND ANY BURIED MATERIAL SPECIFIED IN THE PLANS FOR REMOVAL FROM THE SITE SHALL BE DISPOSED OF AT A LICENSED DISPOSAL FACILITY.
- 2. ALL DISTURBED AREAS SHALL BE RE-VEGETATED. TEMPORARY EROSION, SEDIMENTATION, AND SILTATION MITIGATION DEVICES SHALL BE PLACED PRIOR TO START OF CONSTRUCTION OR LAND DISTURBING ACTIVITIES. DRAINAGE SHALL BE DISPERSED FROM IMPERMEABLE AREAS TO MITIGATE EROSION.
- 3. THE CONTRACTOR SHALL PROVIDE A MINIMUM OF 48 HOURS WRITTEN NOTICE TO THE PROJECT REPRESENTATIVE AND SURVEYOR WHEN REQUESTING SURVEY STAKES.

GRADING NOTES

- 1. THE FOLLOWING SOIL QUANTITIES ARE ESTIMATES ONLY AND ARE NOT ADJUSTED FOR REMOVAL OF VEGETATION OR FOR ROCK INCURRED DURING EXCAVATION. QUANTITY ESTIMATES SHOWN ON THESE PLANS ARE TO BE USED FOR BONDING AND PERMIT PURPOSED ONLY. IT IS THE RESPONSIBILITY OF THE CONTRACTOR TO VERIFY ACTUAL QUANTITIES AND SHRINKAGE FOR THE PURPOSES OF CONSTRUCTION AND BIDDING.
- A. CUT = 445 CY B. FILL = 214 CY C. NET = 231 CY (CUT)


- 2. ALL GRADING AND SITE WORK SHALL BE DONE IN ACCORDANCE WITH THE 2021 CALIFORNIA BUILDING CODE (CBC), CITY STANDARDS, AND THE SOILS REPORT. IN THE CASE OF CONFLICT BETWEEN THE PRECEDING REQUIREMENTS AND THESE PLANS, THE MORE STRINGENT SHALL GOVERN.
- 3. PACIFIC CREST ENGINEERING INC., HEREINAFTER DESCRIBED AS THE GEOTECHNICAL ENGINEER, WILL BE NOTIFIED AT LEAST TWO (2) WORKING DAYS BEFORE SITE CLEARING OR GRADING OPERATIONS COMMENCE, AND WILL BE PRESENT TO OBSERVE THE STRIPPING OF DELETERIOUS MATERIAL AND PROVIDE CONSULTATION TO THE GRADING CONTRACTOR IN THE FIELD.
- 4. ALL GRADING OPERATIONS SHALL CONFORM TO THE RECOMMENDATIONS IN THE SOILS REPORT AS DESCRIBED IN NOTE 3 ABOVE. UNLESS OTHERWISE DIRECTED BY THE GEOTECHNICAL ENGINEER OF RECORD OR AS NOTED ON THESE PLANS.
- 5. ALL PERMANENT CUT OR FILL SLOPES SHALL BE NO STEEPER THAN 2.0 HORIZONTAL TO 1.0 VERTICAL. THE GEOTECHNICAL ENGINEER SHALL SUBMIT A REPORT VERIFYING THE STABILITY OF ALL SLOPES STEEPER THAN 2.0 HORIZONTAL TO 1.0 VERTICAL.
- 6. ALL FILLS SHALL BE BENCHED INTO COMPETENT MATERIAL AND FILL AREA SHALL BE PREPARED AS REQUIRED BY THE GEOTECHNICAL ENGINEER. NO FILL SHALL BE PLACED UNTIL PREPARATION OF THE SITE HAS BEEN APPROVED BY THE GEOTECHNICAL ENGINEER. SCARIFICATION OF THE EXISTING SOIL AT AREAS TO RECEIVE FILL SHALL BE PERFORMED. ALL FILL MATERIAL SHALL BE IN ACCORDANCE WITH THE SOILS REPORT.
- 7. FIELD OBSERVATION, INSPECTIONS, AND TESTING DURING THE GRADING OPERATIONS, AS DESCRIBED HEREIN, SHALL BE PROVIDED BY THE GEOTECHNICAL ENGINEER, SO THAT A DECISION CAN BE FORMED REGARDING THE ADEQUACY OF THE SITE PREPARATION, THE ACCEPTABILITY OF FILL MATERIALS, AND THE EXTENT TO WHICH THE EARTHWORK CONSTRUCTION AND THE DEGREE OF COMPACTION COMPLY WITH THE PROJECT'S GEOTECHNICAL SPECIFICATIONS AND IS SUITABLE TO SUPPORT THE INTENDED STRUCTURES.
- 8. THE CONTRACTOR SHALL FURNISH THE GEOTECHNICAL ENGINEER WITH A SUBMITTAL INDICATING THE TYPE OF CONCRETE, MIX QUANTITIES, AND MASONRY MATERIALS TO BE USED IN THE CONSTRUCTION OF ALL FOUNDATIONS. FOUNDATION WALLS, AND RETAINING WALLS FOR PRIOR APPROVAL.
- 9. THE CONTRACTOR SHALL PROVIDE UNIFORM GRADES BETWEEN CONTROL ELEVATIONS WITH SMOOTH VERTICAL CURVES AT GRADE BREAKS. THE EDGES OF ALL GRADING WORK SHALL BE ROLLED AND CONTOURED TO PRESENT A NATURAL LOOKING APPEARANCE THAT BLENDS WITH ADJACENT NATURAL GRADES AND AVOIDS PRISMATIC FORMS.
- 10. NO AREA SHALL BE GRADED SOONER THAN IS NECESSARY FOR CONSTRUCTION TO REDUCE THE AMOUNT OF TIME THAT THE SOILS ARE DEVOID OF PLANT MATERIAL.
- 11. PRIOR TO FINAL INSPECTION, THE GEOTECHNICAL ENGINEER SHALL CERTIFY THAT ALL GRADING, SCARIFICATION, AND COMPACTION WAS DONE IN ACCORDANCE WITH THE RECOMMENDATIONS IN THE SOILS REPORT AND AS NOTED ON THESE PLANS.
- 12. THE GEOTECHNICAL ENGINEER SHALL INSPECT AND CERTIFY THAT ALL FOUNDATION EXCAVATIONS COMPLY WITH THE RECOMMENDATIONS OF THE SOILS REPORT.



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SIGNATURE 7/9/2024 DATE SIGNED

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> INFRAST WATSONVILL Z RE OF G CITY

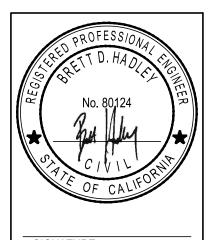DESIGNERS: BDH DRAWN BY: WES DATE: 07/09/24 DRAWING NO. C-1.1



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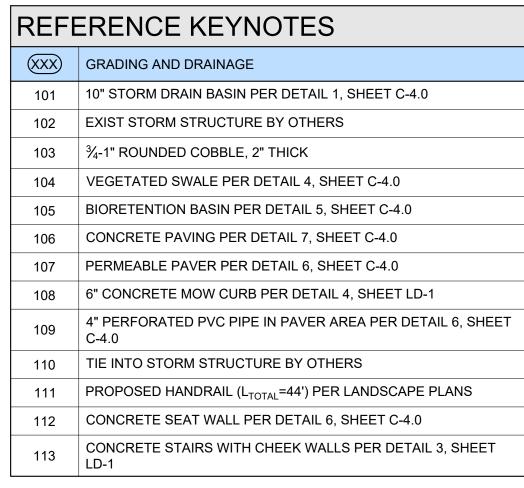
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OF WATSONVILLE PARK GREEN INFRAST CITY

DESIGNERS: SLB DRAWN BY: MCC DRAWING NO. C-1.2 3 OF 19 SHEETS FOR REDUCED PLANS 0 1 2

FILE NAME: 1535-0007-GPLN.DWG Plot Date: 7/9/2024

4 ORIGINAL SCALE IS IN INCHES 5






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ITY OF WATSONVILLE ARK GREEN INFRASTRUCTURE

JOB #: 1535-0007

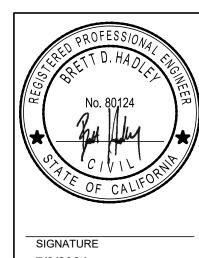DESIGNERS: BDH


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DATE: 07/09/24

DRAWING NO.

C-2.0

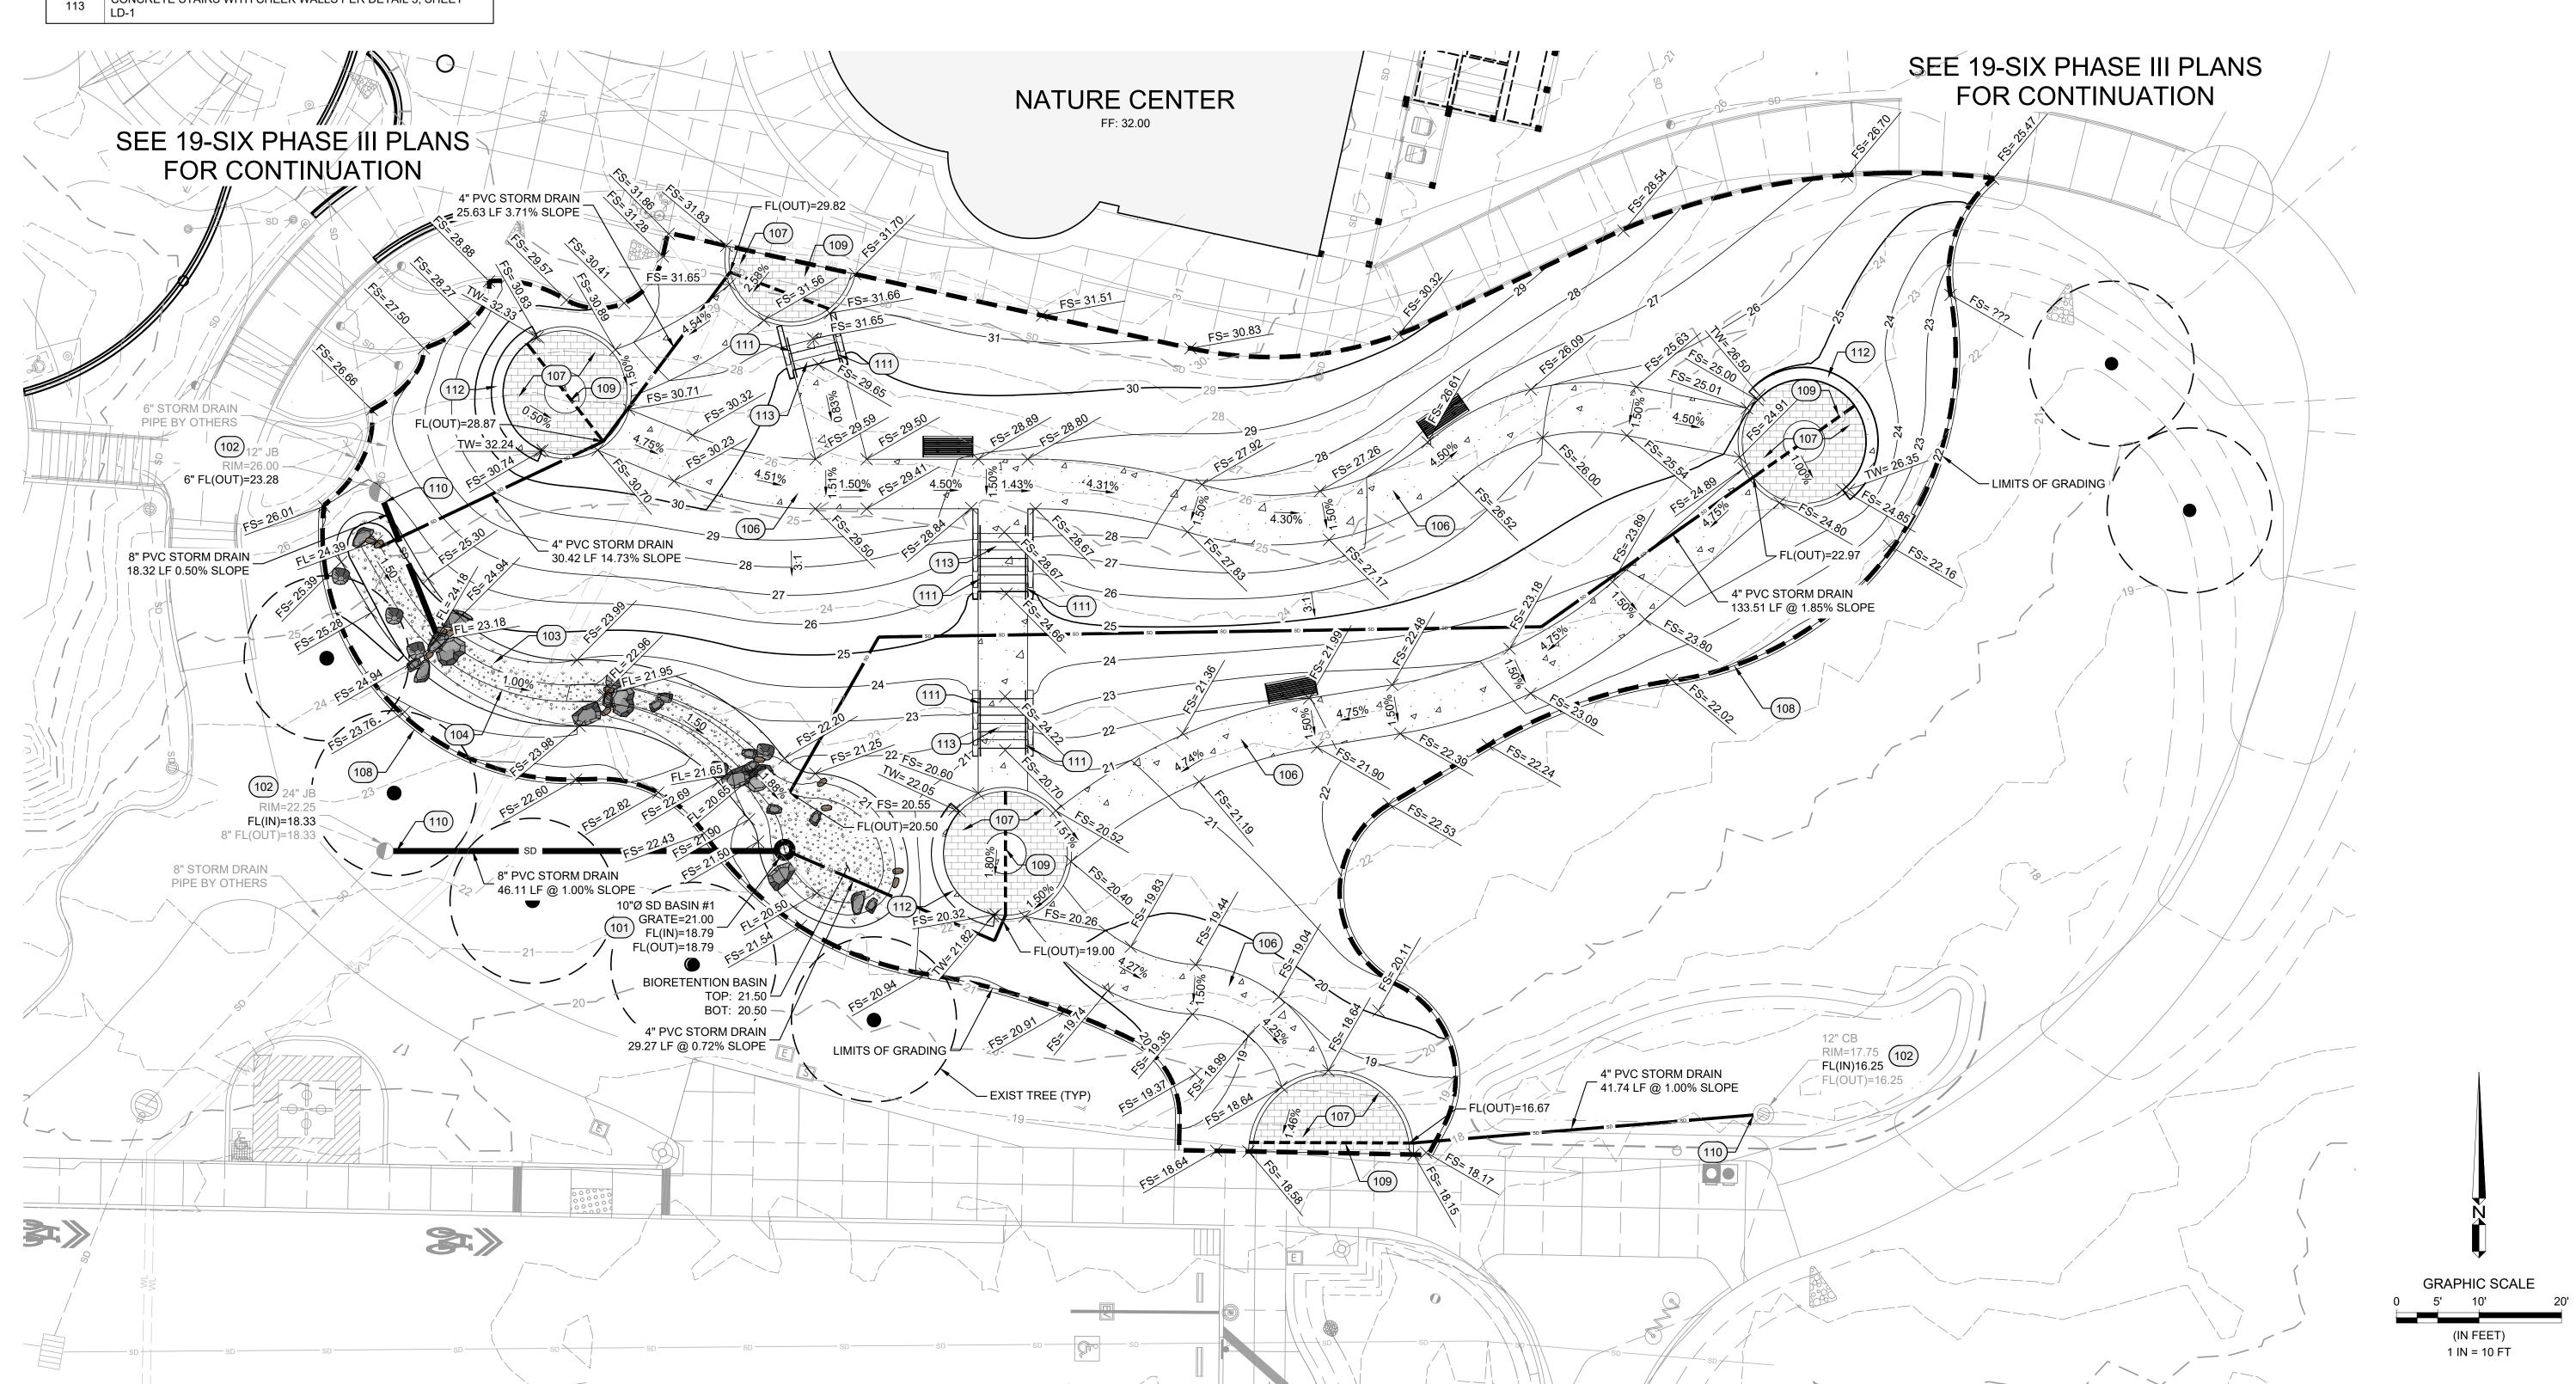4 OF 19 SHEETS



FOR REDUCED PLANS

ORIGINAL SCALE IS IN INCHES

ORIGINAL SCALE IS IN INCHES

REFE	ERENCE KEYNOTES	FIBER ROLL IN
XXX	TEMPORARY EROSION CONTROL	SLOPE PERCENTAG
201	FIBER ROLL PER CALTRANS BMP SC-5 AND T56, SEE SHEET C-3.1	0%-25%
202	TEMPORARY DRAINAGE INLET PROTECTION TYPE 3B PER	25%-50%

202	CALTRANS BMP SC-10 AND T62, SEE SHEET C-3.1
203	TEMPORARY CONSTRUCTION STAGING AREA (EQUIPMENT, STORAGE, HAZARDOUS MATERIALS, WASTE, AND STOCKPILES) PER DETAIL 1, SEE SHEET C-3.1

204	TEMPORARY CONSTRUCTION ENTRANCE PER CALTRANS T58,				
204	SEE SHEET C-3.1				


	FIBER ROLL INSTALLATION GUIDELINES					
	SLOPE PERCENTAGE	SHEET FLOW LENGTH NO TO EXCEED				
	0%-25%	20 FEET				
	25%-50%	15 FEET				
	>50%	10 FEET				



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CITY OF WATSONVILLE
PARK GREEN INFRASTRUCTURE

JOB #: 1535-0007

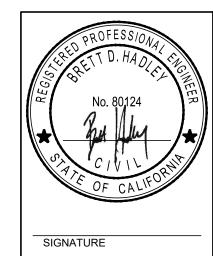DESIGNERS: BDH

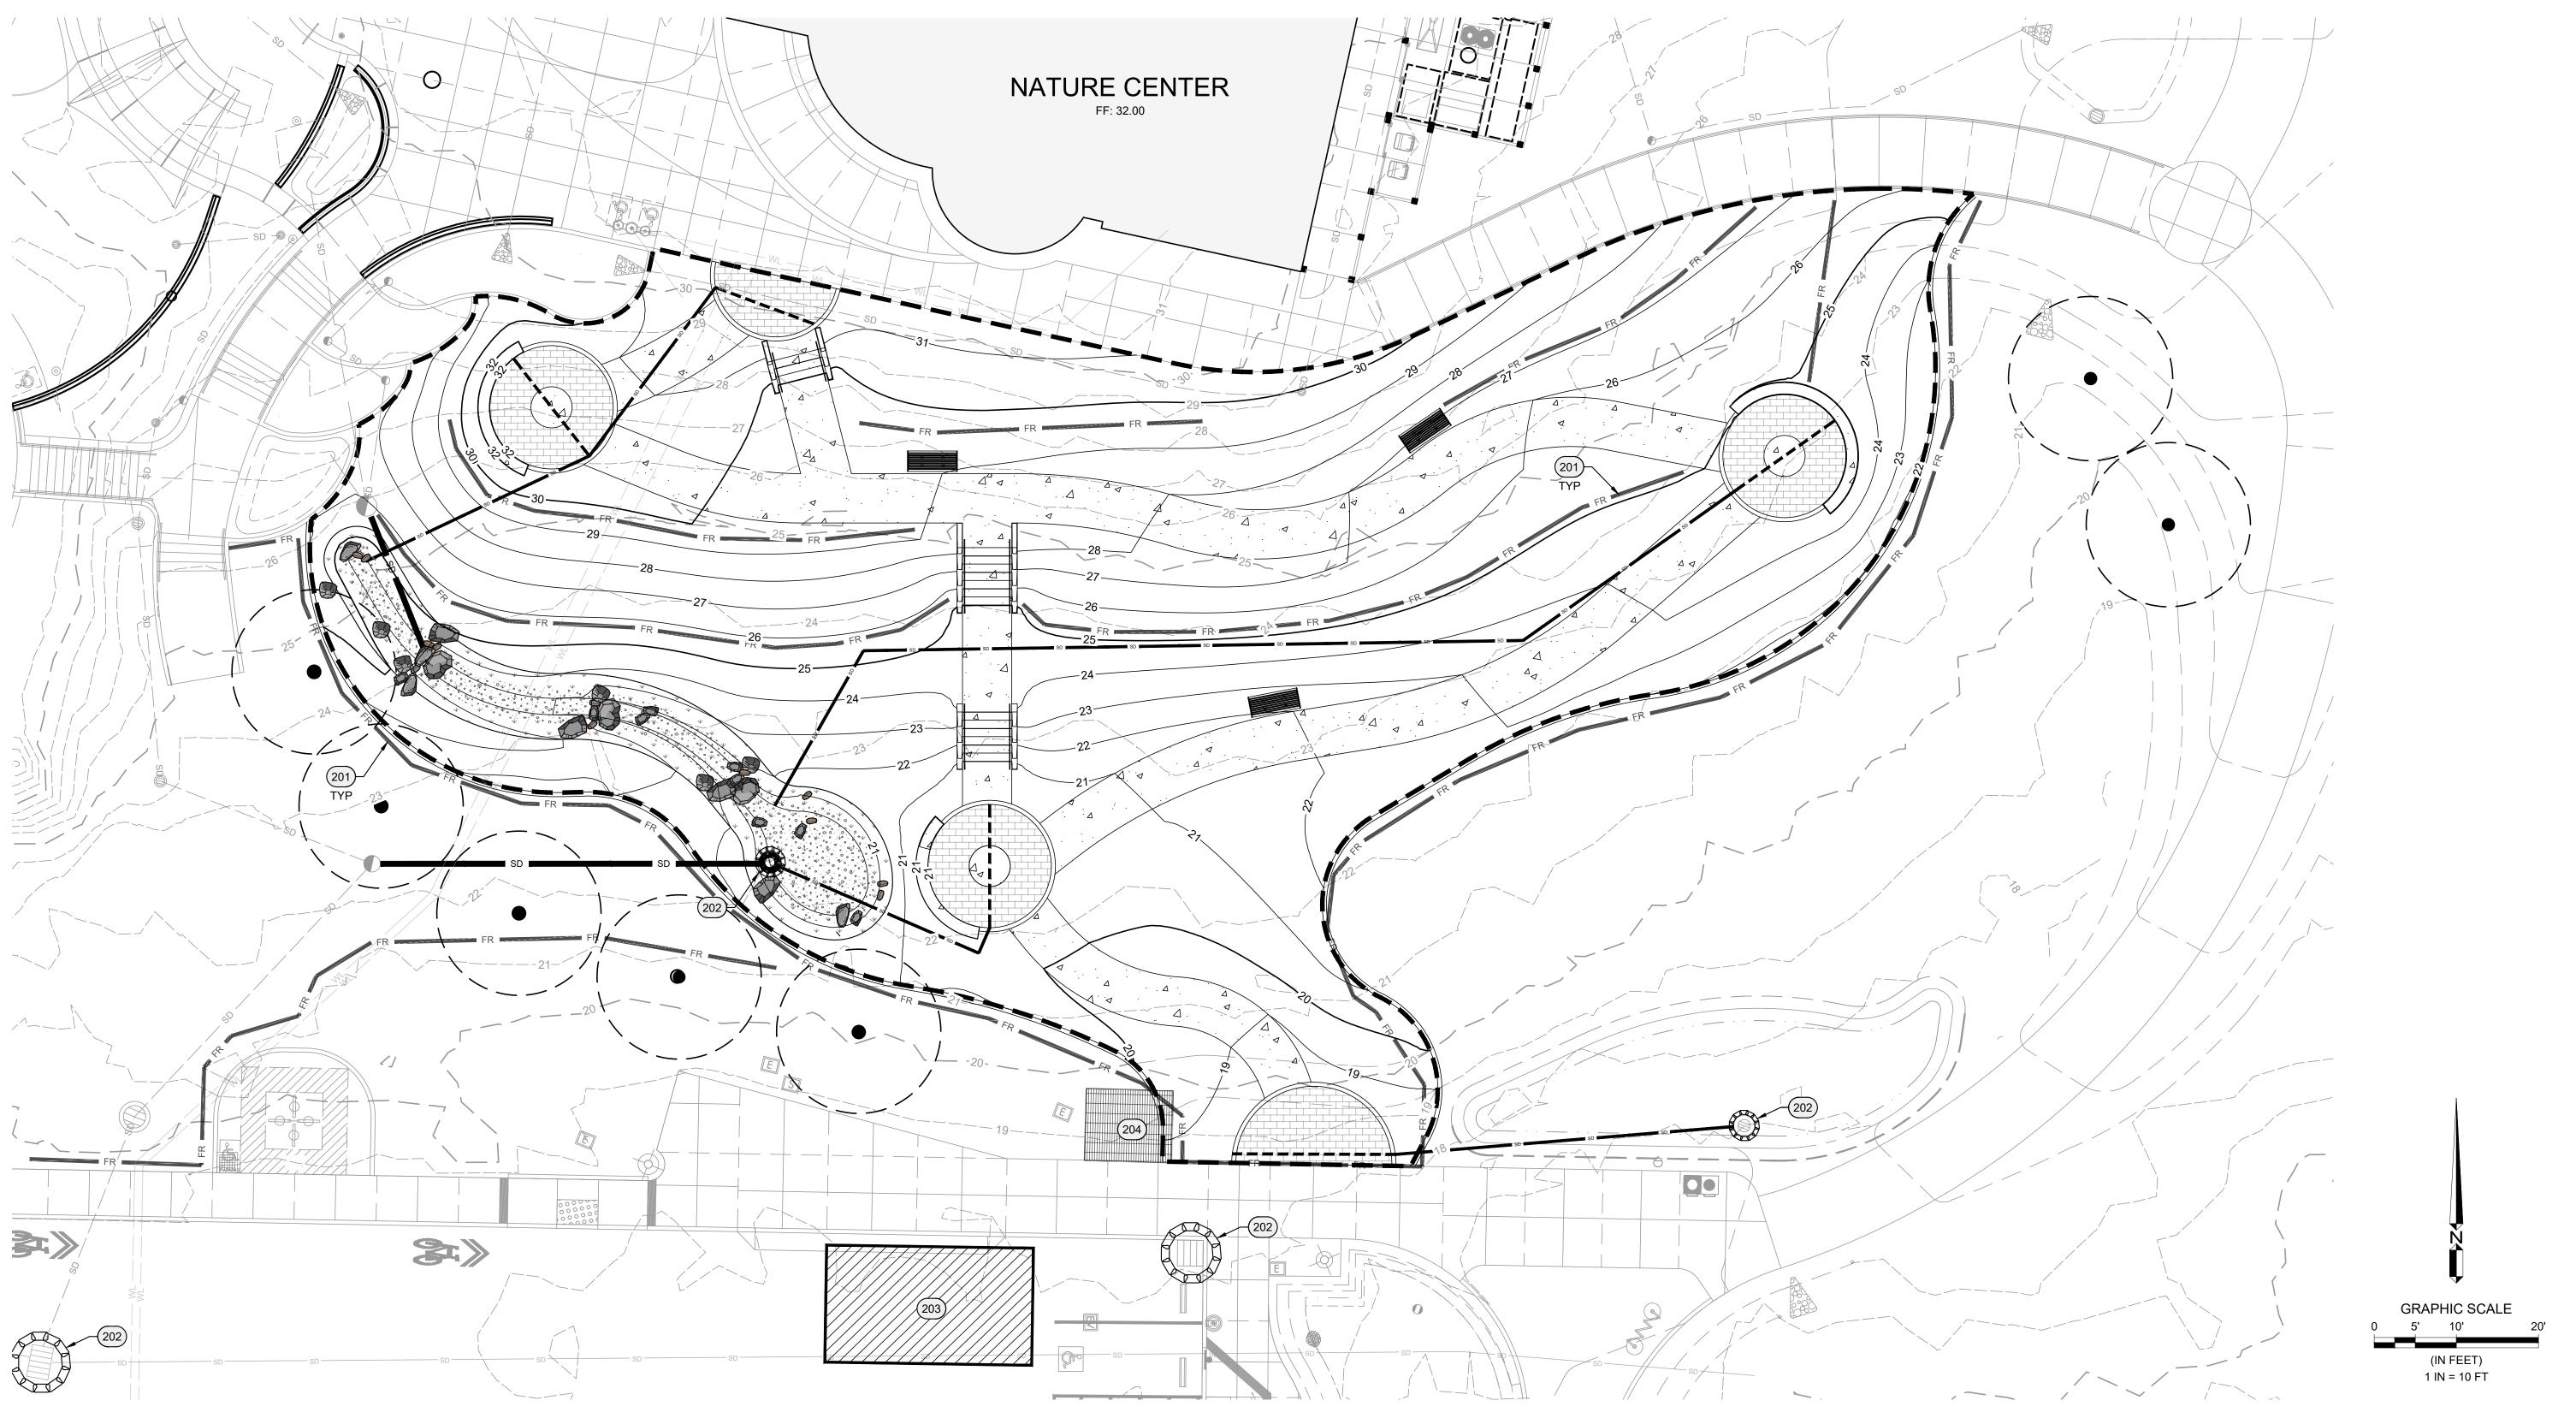
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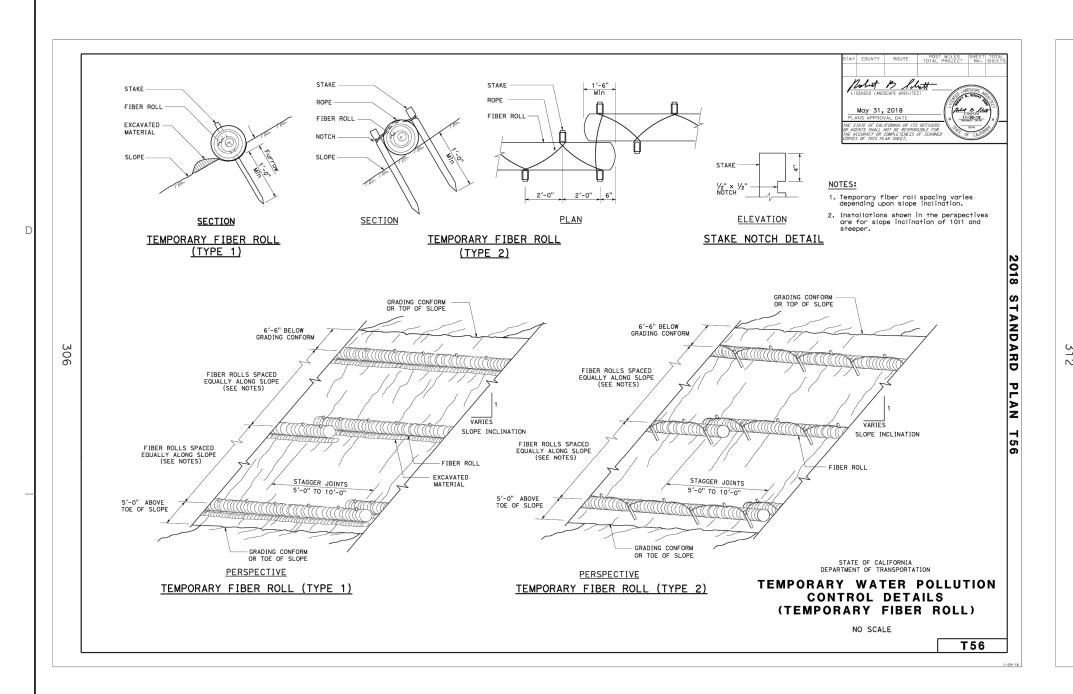
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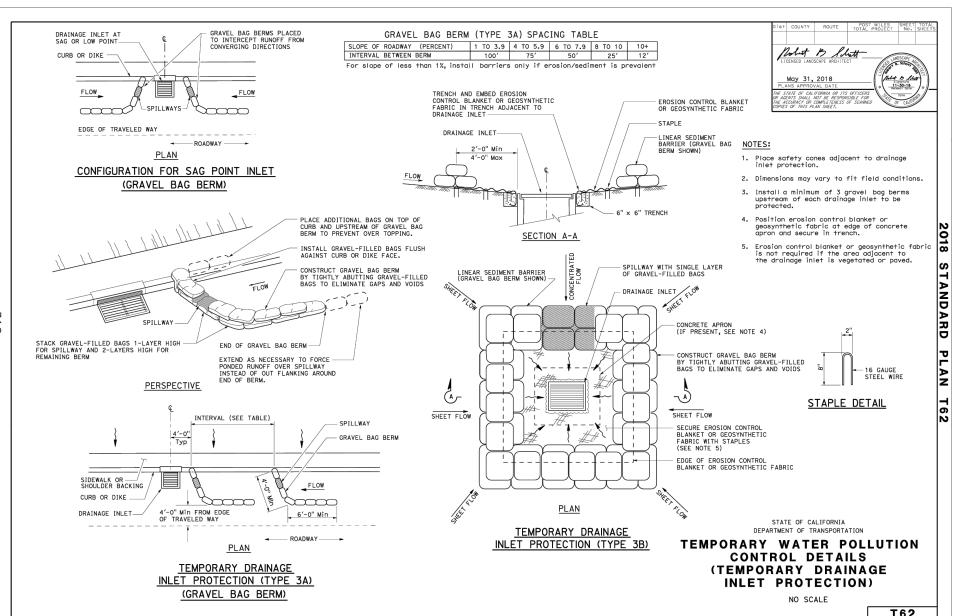
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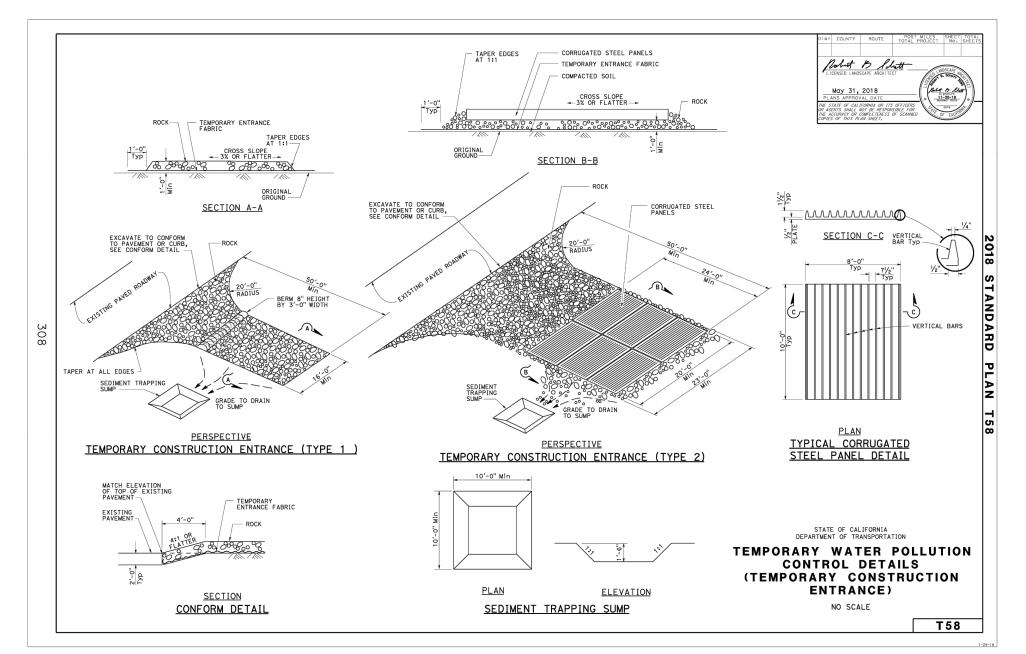


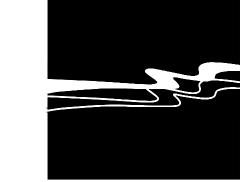
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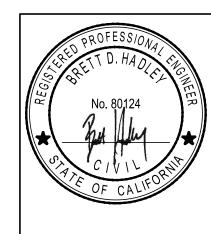




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FUEL STORAGE/HAZ MAT AREA WITH SECONDARY CONTAINMENT

CONSTRUCTION EQUIPMENT PARKING

CONSTRUCTION TRASH/RECYCLING

CONCRETE/PAINT WASHOUT

CONSTRUCTION TRAILER AREA

CONSTRUCTION EQUIPMENT PARKING

CONSTRUCTION TRAILER AREA

CONSTRUCTION TRAILER AREA

SF

CONSTRUCTION STAGING AREA

Scale: N

CITY OF WATSONVILLE RAMSAY PARK GREEN INFRASTRUCTURE

JOB #: 1535-0007

DESIGNERS: BDH

DRAWN BY: WES

DATE: 07/09/24

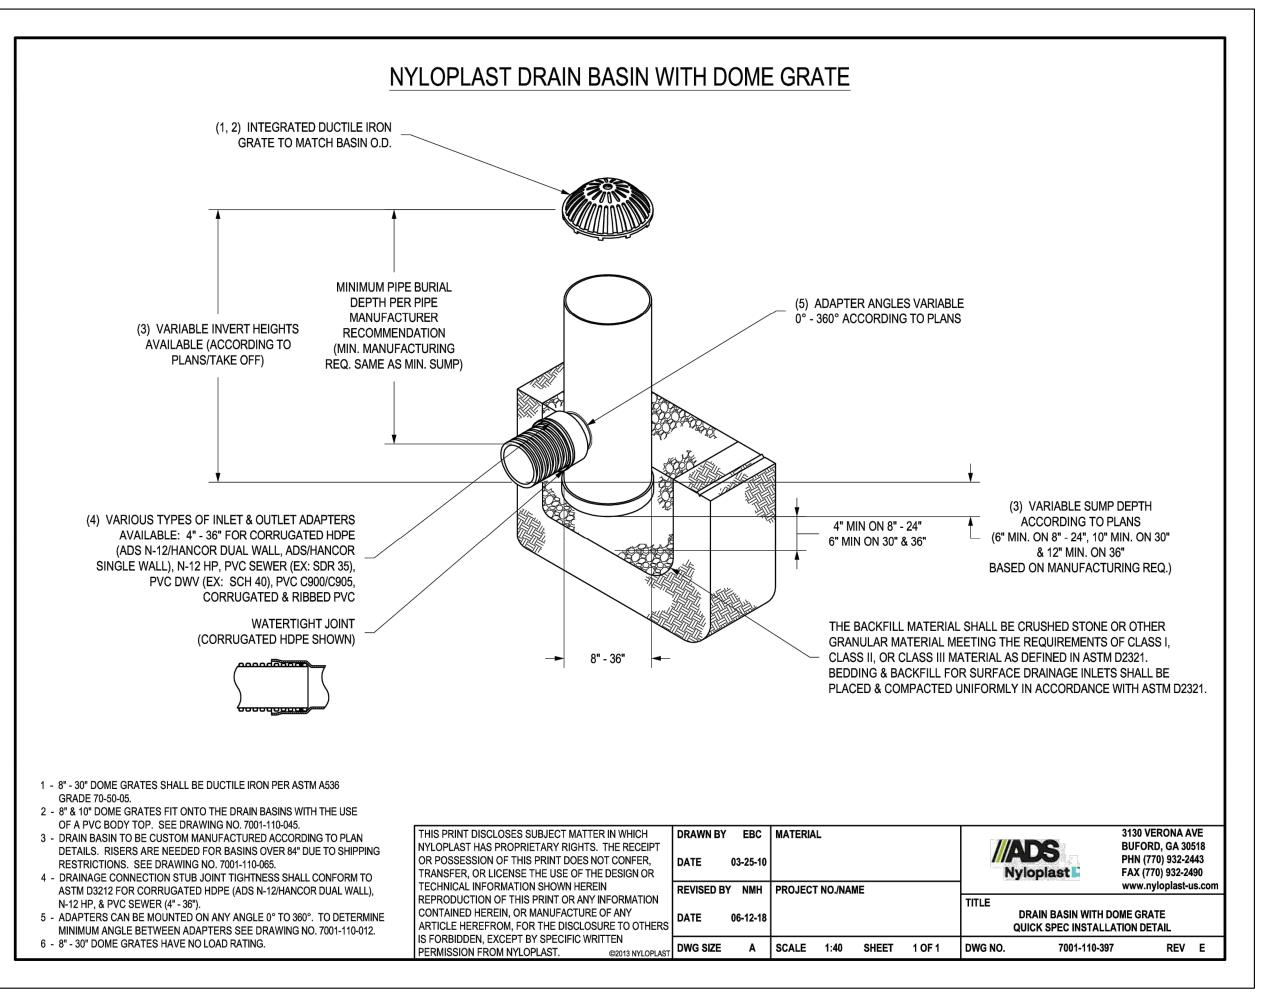
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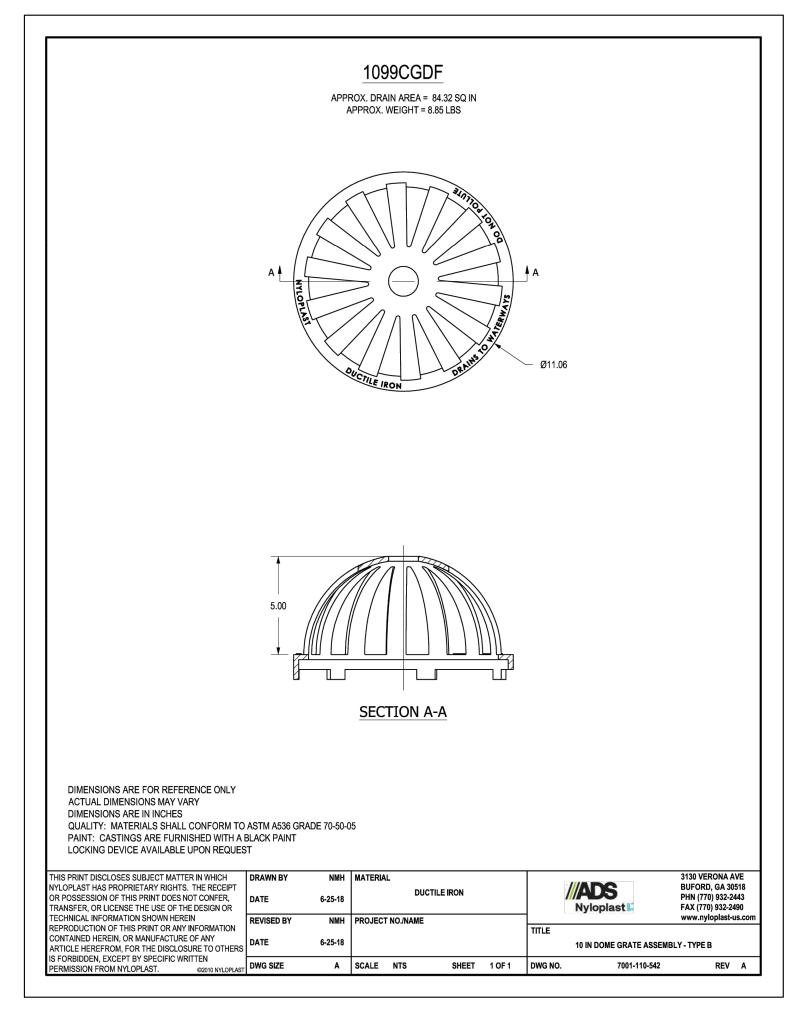
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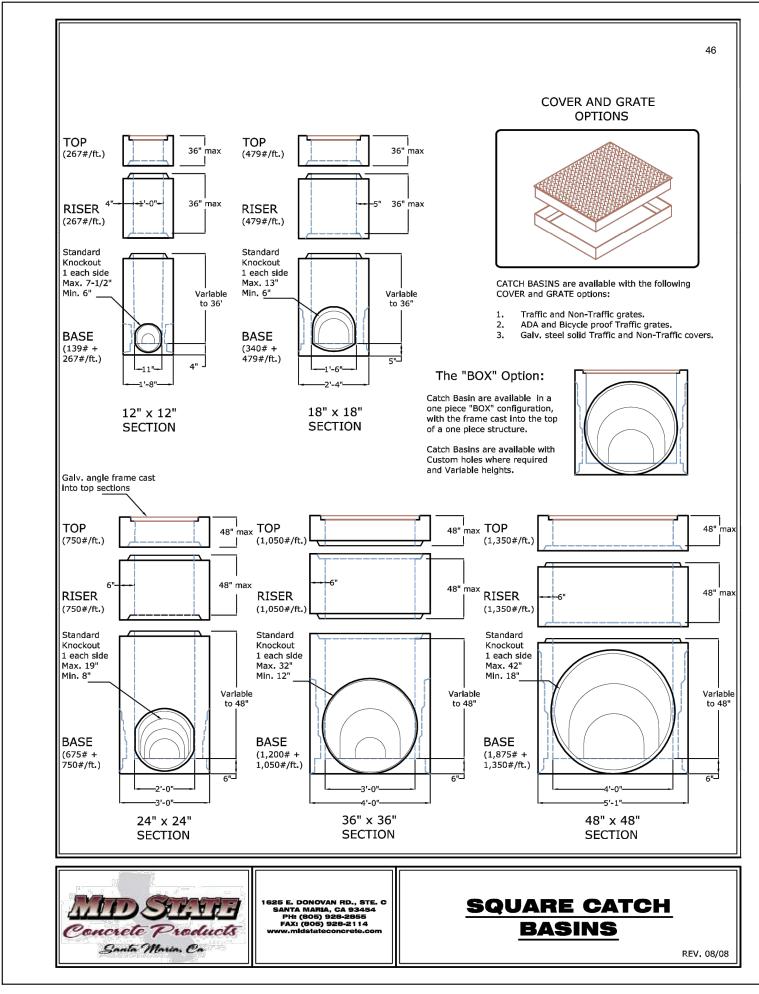
6 OF 19 SHEETS


FILE NAME: 1535-0007-DETL.DWG Plot Date: 7/9/2024

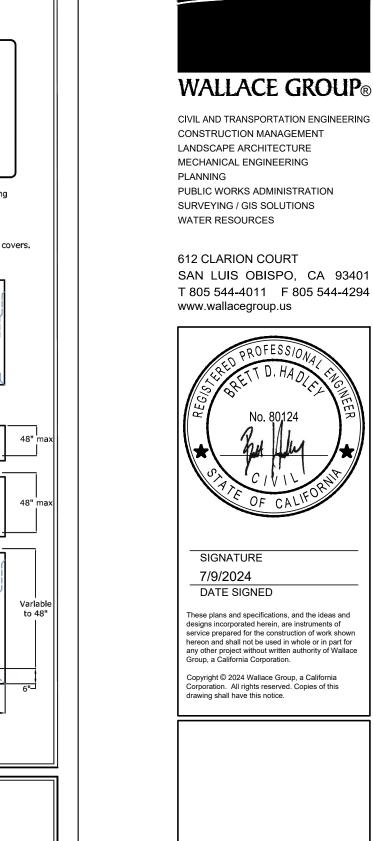FOR REDUCED PLANS ORIGINAL SCALE IS IN INCHES











(5) CONCRETE FINISH AND PATTERN PER LANDSCAPE

NOTE: PROVIDE SCORE JOINTS 5' O.C. AND 10' O.C. FOR

Scale: 1"=1'

(6) (2) #3 BARS CONTINUOUS

EXPANSION JOINT

CONCRETE SECTION

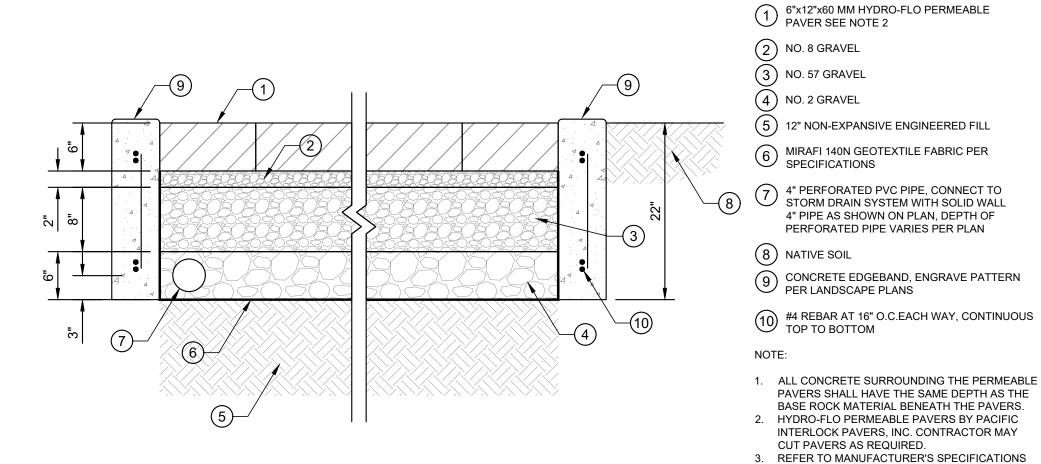
VARIES PER PLAN

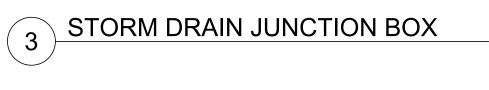
PROFILE

SECTION

1.50% _







LEGEND:

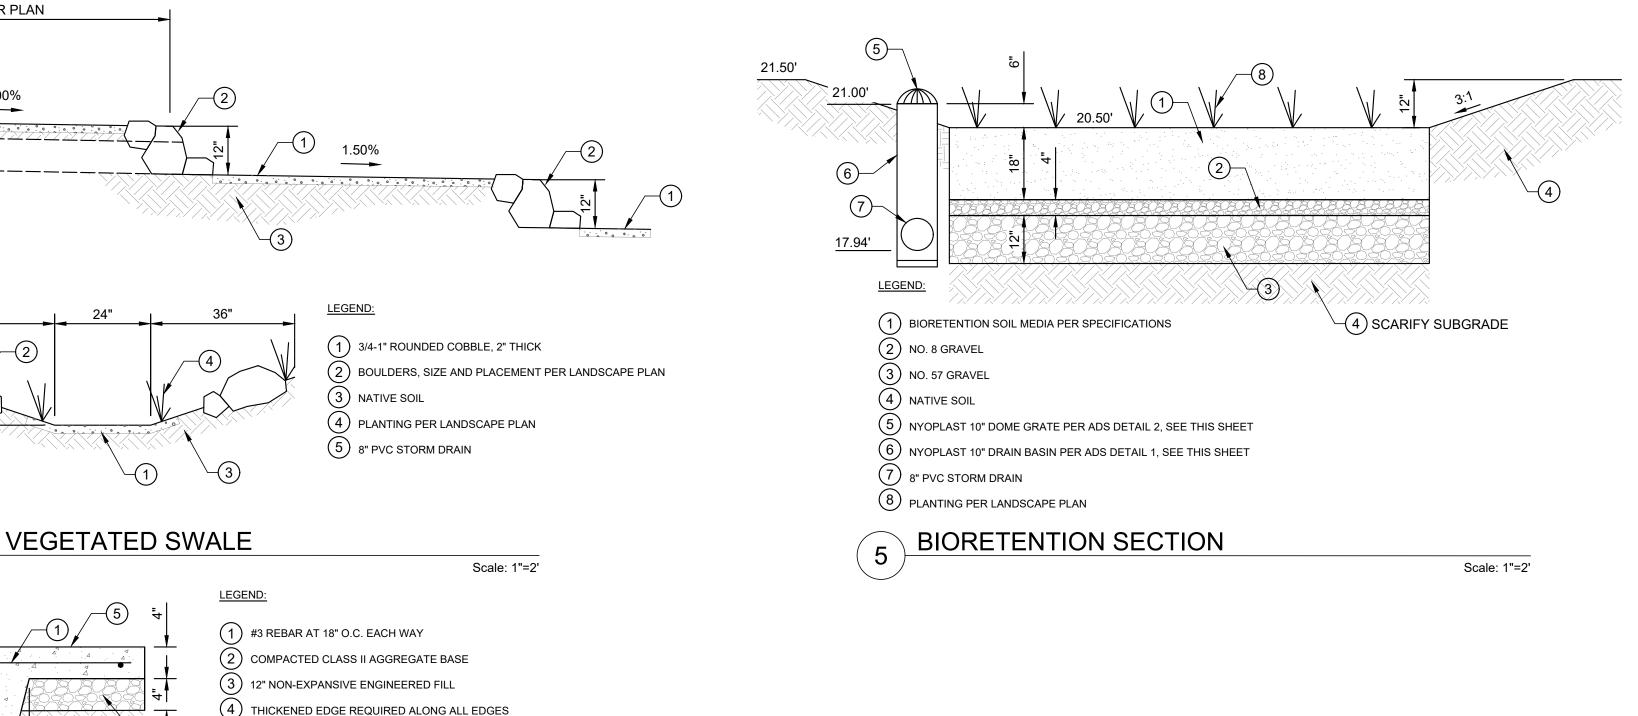
SPECIFICATIONS

4" PIPE AS SHOWN ON PLAN, DEPTH OF

PERFORATED PIPE VARIES PER PLAN

AND RECOMMENDATIONS PRIOR TO


INSTALLATION.





PERMEABLE PAVERS Scale: 1"=1'

RUC. WATSONVILLE EN INFRAS RE OF Ŋ CITY

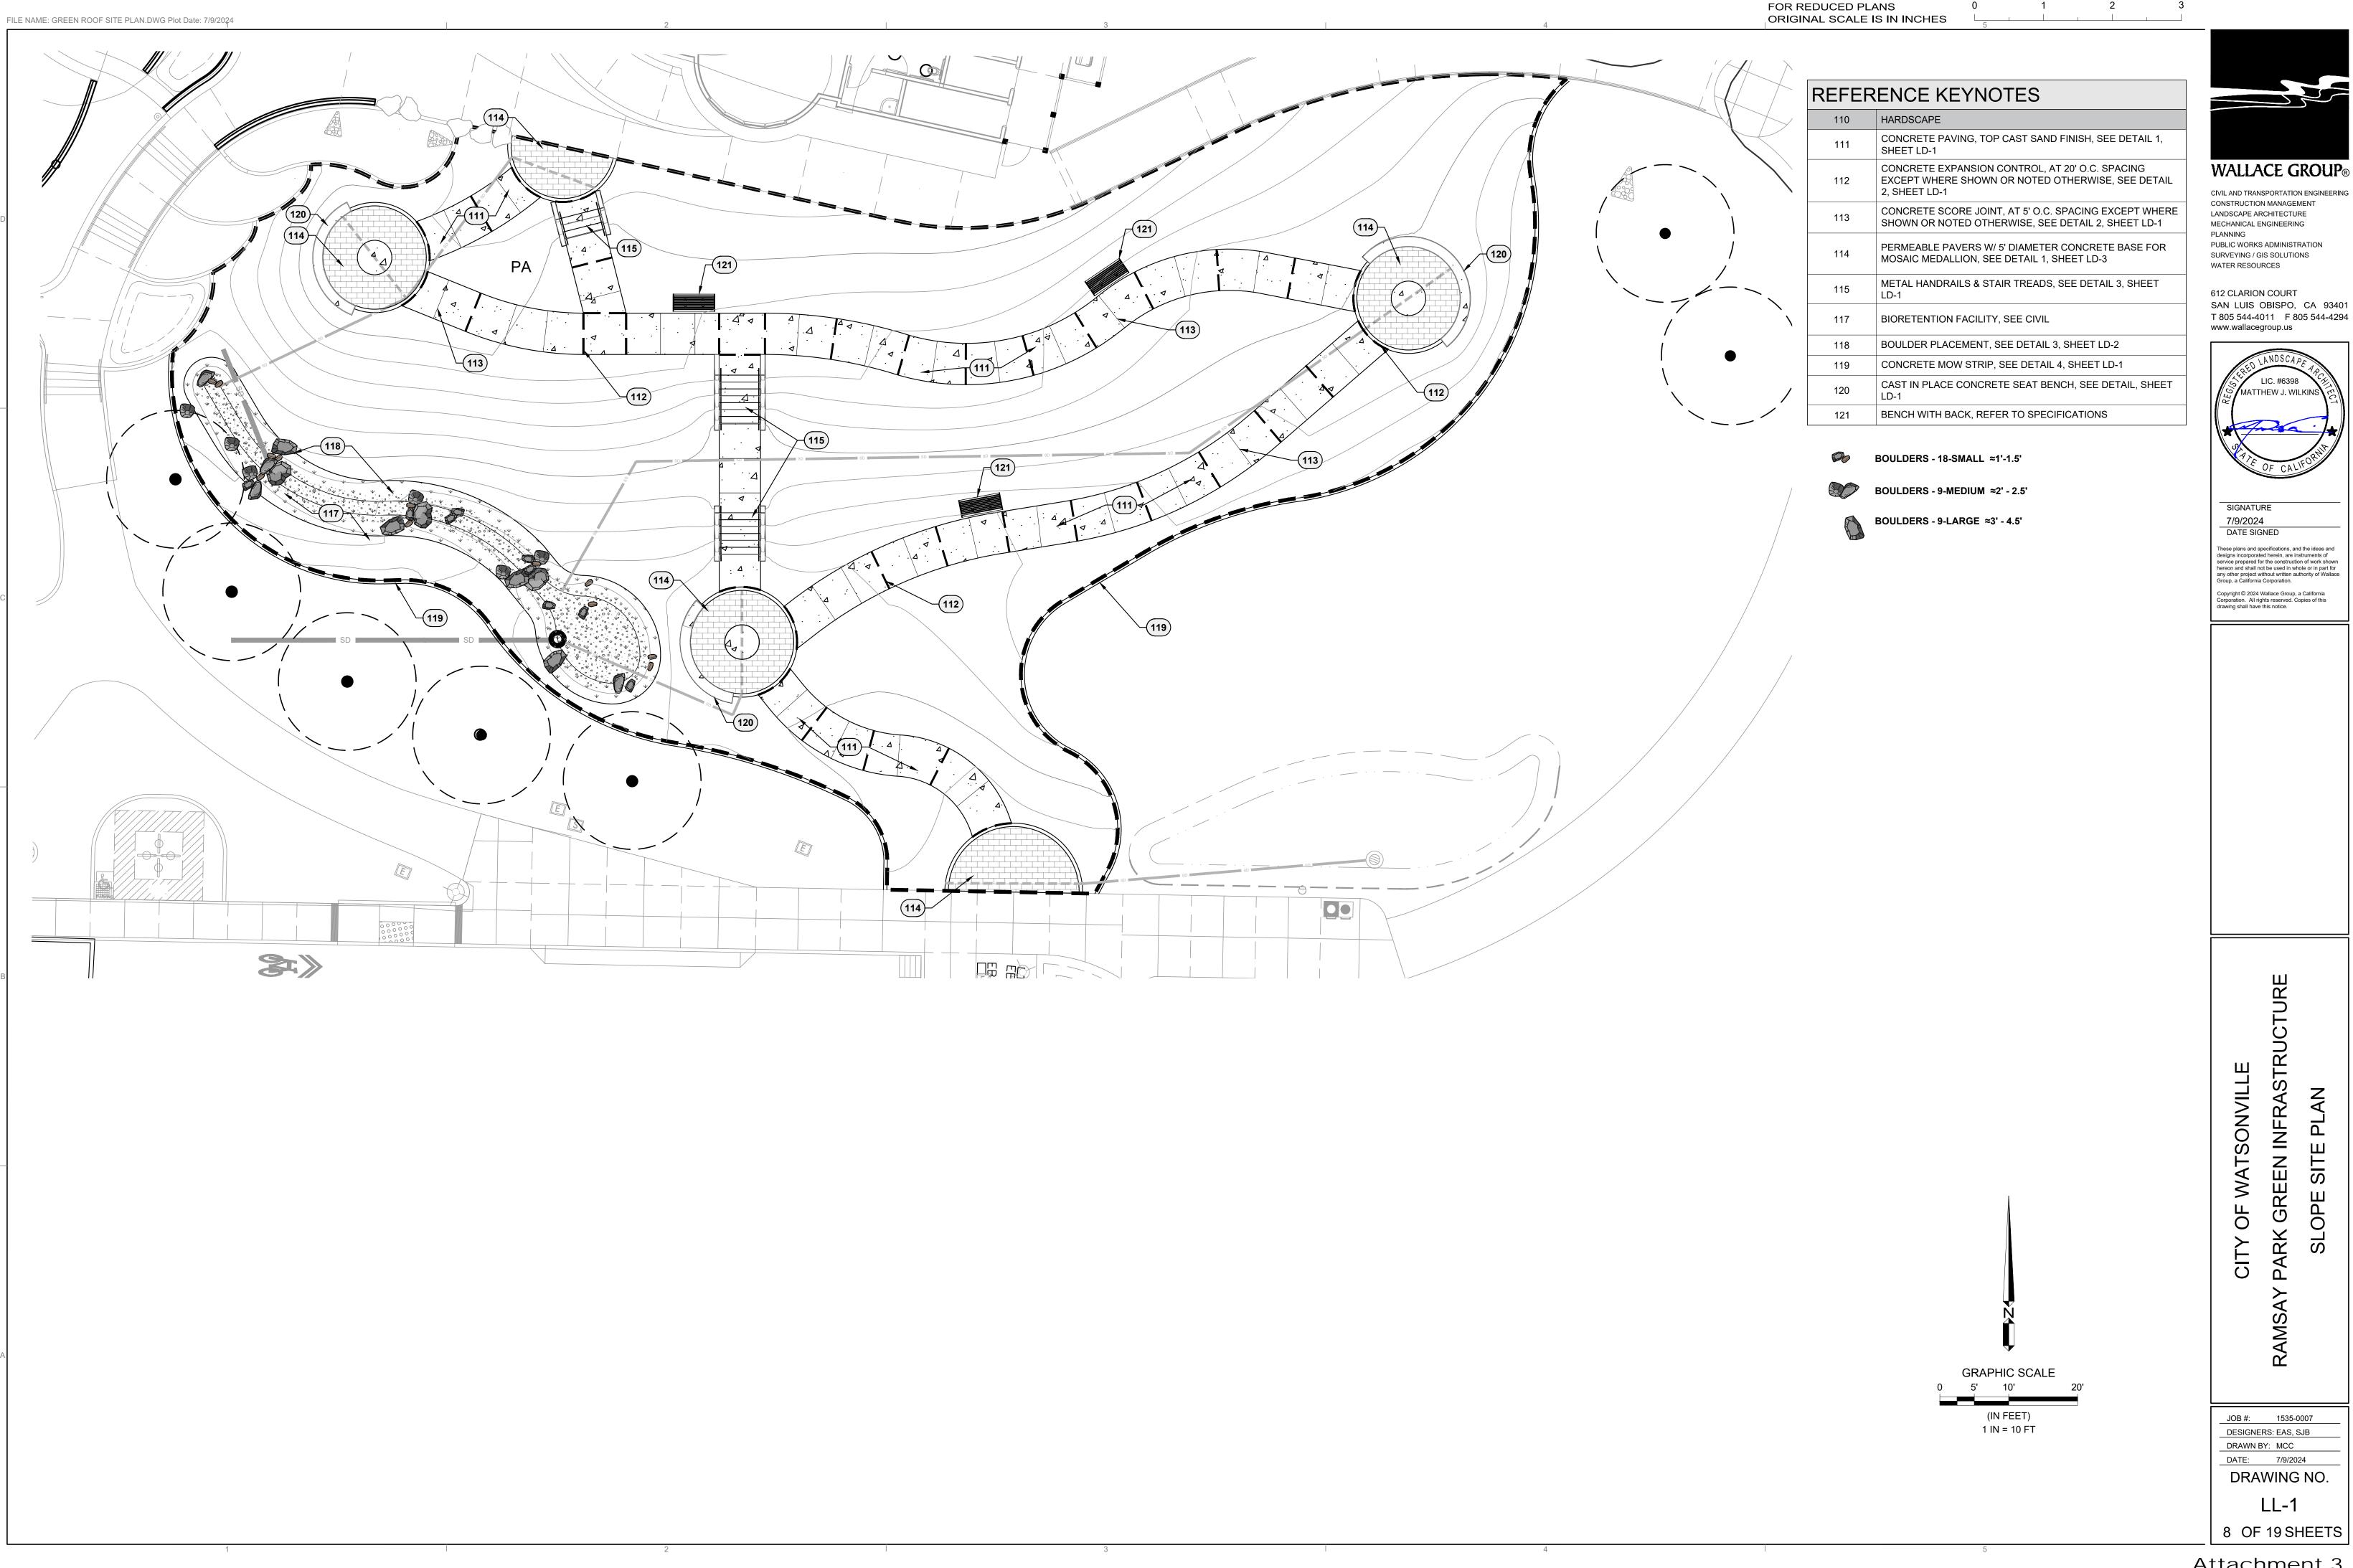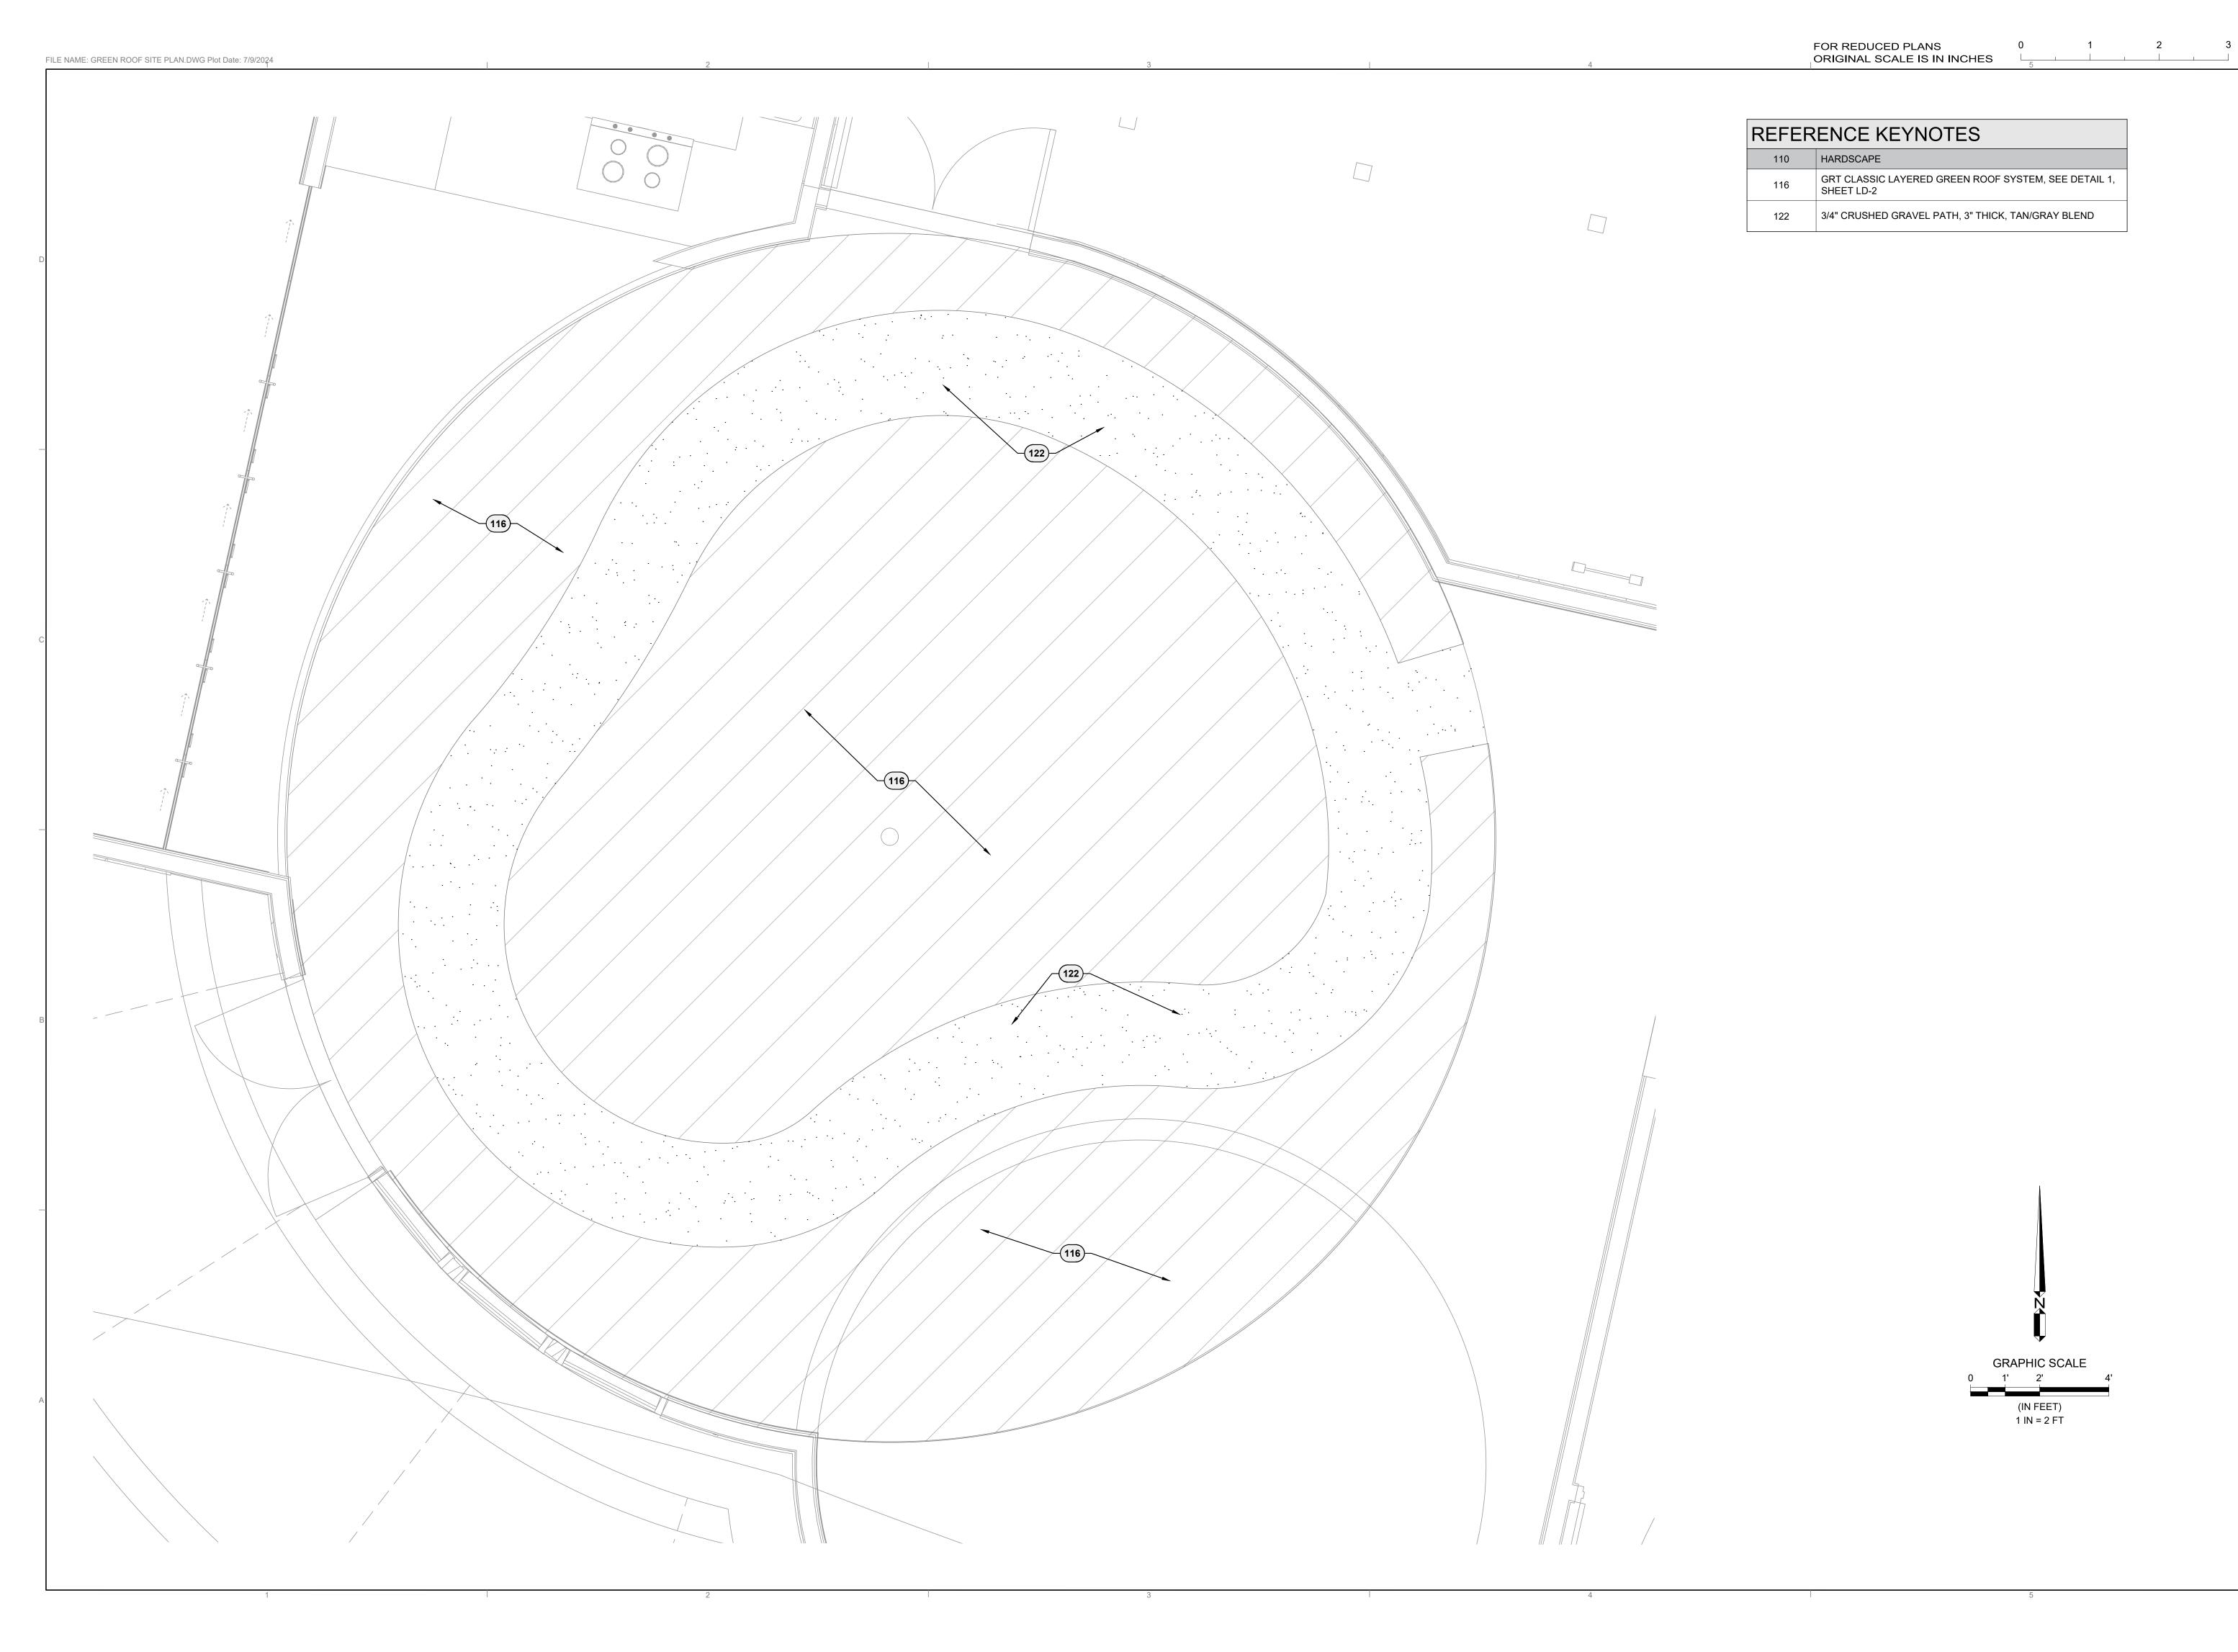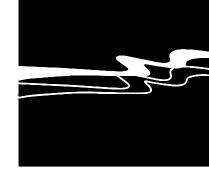DESIGNERS: BDH DRAWN BY: WES DATE: 07/09/24 DRAWING NO. C-4.0 7 OF 19 SHEETS







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WATTHEW J. WILKINS

OF CALIFORNIA

SIGNATURE
7/9/2024
DATE SIGNED

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CITY OF WATSONVILLE ASAY PARK GREEN INFRASTRUCTURE

JOB #: 1535-0007

DESIGNERS: EAS, SJB

DRAWN BY: MCC

DATE: 07/09/24

DRAWING NO.

LL-2

9 OF 19 SHEETS


EXPANSION JOINT

CONTROL JOINT

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> RUCTURE INFRAST Z H RE G

DESIGNERS: EAS/SLB DRAWN BY: MCC DATE: 07/09/24 DRAWING NO. LD-1

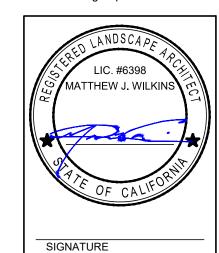LEGEND:

(1) CONCRETE PAVING

(2) JOINT BACKER MATERIAL OR POLYFOAM BACKER MATERIAL

(3) SIKAFLEX - 1A JOINT SEALANT AT 1/2" DEPTH, COLOR TO MATCH ADJASCENT HARDSCAPE SURFACE

(4) 1/4" RADIUS TYP.

(5) FACE OF CURB, CONCRETE PAVING, WALL, BUILDING OR STRUCTURE - WHERE OCCURS

(6) EXPANSION JOINT WIDTH: PEDESTRIAN PAVEMENT - 3/8" VEHICULAR PAVEMENT - 1/2"

(7) CONCRETE REINFORCING #3 REBAR @ 18" O.C. BOTH DIRECTIONS IN MIDDLE OF SLAB

(8) SAWCUT JOINT PER PLANS. 1/2" DEPTH FOR PEDESTRIAN PAVING. 3/4" DEPTH FOR VEHICUALR PAVING. STOPPING JOINT SHORT OF GRATES, WALLS, BUILDING, ETC. IS UNACCEPTABLE.

(9) NO 3 BAR 24" DOWEL O.C. WITH SLEEVE

NOTES:

A. SPACE EXPANSION JOINTS PER PLANS OR AT 10' O.C. MAX. SPACE CONTROL JOINTS PER PLANS OR AT 5' O.C. MAX.

B. WHERE CONCRETE ABUTS WALLS/BUILDING PROVIDE CONTINUOUS EXPANSION JOINT MATERIAL (SEALED, NO DOWEL). TYP.

LEGEND:

BENCH WITH BACK

(1) FINISH SURFACE, REFER TO PLANS

(2) TYPICAL CONCRETE POST FOOTING

A. ALL STL. MEMBERS COATED

POWDER COATING.

B. ANTIQUE MAHOGANY

W/ ZINC RICH EPOXY THEN

FINISHJED W/ POLYESTER

TEXTURED SLAT OPTION

AS DIMENSIONED

P-RA-06

DOWELED EXPANSION JOINT

LEGEND:

1) CONTRACTOR SHALL PAINT WARNING STRIPS WITH YELLOW TRAFFIC PAINT

(2) 1/2" BULLNOSE ON ALL STEPS. NOSING 1/4" RADIUS, SPACED 3/4" APART

(3) EXTEND 12" MIN. LEVEL DISTANCE TO LANDING SURFACE BEFORE RETURNED

(4) 1-1/2" DIAMETER SCHED 40 STEEL PIPE HANDRAIL, GALVANIZED

5 NO. 3 NOSING BAR, BEND DOWN 4" AT ENDS,

SHOULD BE PLACED MIN. 3" FROM EDGE (6) NO. 4 REBAR 9" O.C. E.W., 3" MIN. CLEARANCE FROM

7) 3 X 3 X 1/2" STEEL PLATE WELDED TO BOTTOM OF RAIL, TYPICAL

(8) TYPICAL CONCRETE POST FOOTING

9 3/8" WIDE ASPHALT IMPREGNATED FIBROUS EXPANSION JOINTS, EACH END

(10) 6" DEEP CLASS 2 AGGREGATE COMPACTED TO 95%,

(11) 'SPEED LOAD' 3/4" X 12" SLEEVE W/ 24" SMOOTH DOWEL AT 18" O.C. CENTERED IN SLAB

STAIRS AND HANDRAILS

(12) SIKA FLEX JOINT AT ALL PIPE LOCATIONS

(13) CHEEK WALL

(14) 95% COMPACTED SUBGRADE

(15) #4 REBAR AS SHOWN

(16) 3/8" RADIUS TYP.

(17) CONCRETE STEPS

1'-0" **CHEEK WALL FRONT SECTION** 1'-0"

LEGEND:

1 PLANTING AREA

(2) NATURAL GREY CONCRETE MOW BAND, PCC, CLASS B. SMOOTH TROWEL FINISH.

(3) 1" RADIUS TOOLED EDGE

(4) TURF

323015.06-11

5) #3 REBAR CONTINUOUS

6 SUBGRADE, COMPACT TO 95% RELATIVE COMPACTION 6" BELOW SURFACE.

(RE-BAR BY INSTALLER)

74"

S-1 EMBEDMENT

500-60TX

00

A. UNLESS OTHERWISE SHOWN ON PLANS, PLACE WEAKENED PLANE JOINTS AT 10' AND EXPANSION JOINTS AT 30' ON CENTER.

B. CONCRETE SHALL BE 3000 PSI.

CONCRETE MOW STRIP

321613.16-17

LEGEND:

1) 1/2" RADIUS EDGES

(8) FINISH GRADE

PLANS

(3) #4 SHEAR TIES @ 16" O.C.

4 AG BASE COMPACTED TO 95% RELATIVE COMPACTION

(6) COMPACTED SUBGRADE PER SOILS

7) 6" WIDE BY 1' DEEP 3/4" SIZE DRAIN

(10) EXPANSION JOINT/DOWEL JOINT AT LOCATIONS WHERE SEATWALL IS

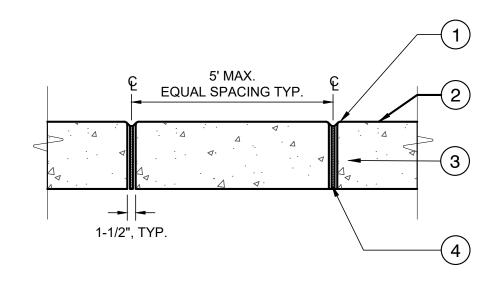
(11) TOP-CAST SAND FINISH, TYP. ALL SIDES, DAYTON SUPERIOR OR

APPROVED EQUAL

9 FINISH SURFACE, PERMEABLE PAVERS, ADJACENT SURFACE VARIES, REFER TO

ADJASCENT TO CONCRETE, REFER TO

2) #4 REBAR @ 12" O.C. BOTH WAYS, TYP.



LEGEND:

1) 1/2" RADIUS ALL EXPOSED EDGES, TYP.

(2) TALL CURB OR SEATWALL, REFER TO PLANS

3 CHAMFERED JOINT SHALL EXTEND FULL DEPTH OF CONCRETE FEATURE

(4) 3/4" REVEAL ALL EXPOSED SIDES, TYP.

CHAMFERED EXPANSION JOINT AT SEATWALL P-RA-04

3/32" = 1'-0"

NOTE:

A. IF SEAT WALL HAS ADJACENT PLANTING AREA /

OF WALL BELOW GRADE.

B. AMEND SOIL AND INSTALL ROOT BARRIER, REFER TO PLANTING PLAN AND SPECIFICATIONS. WIDE CONCRETE SEAT WALL

SYNTHETIC TURF AREA, CONTRACTOR SHALL APPLY 2

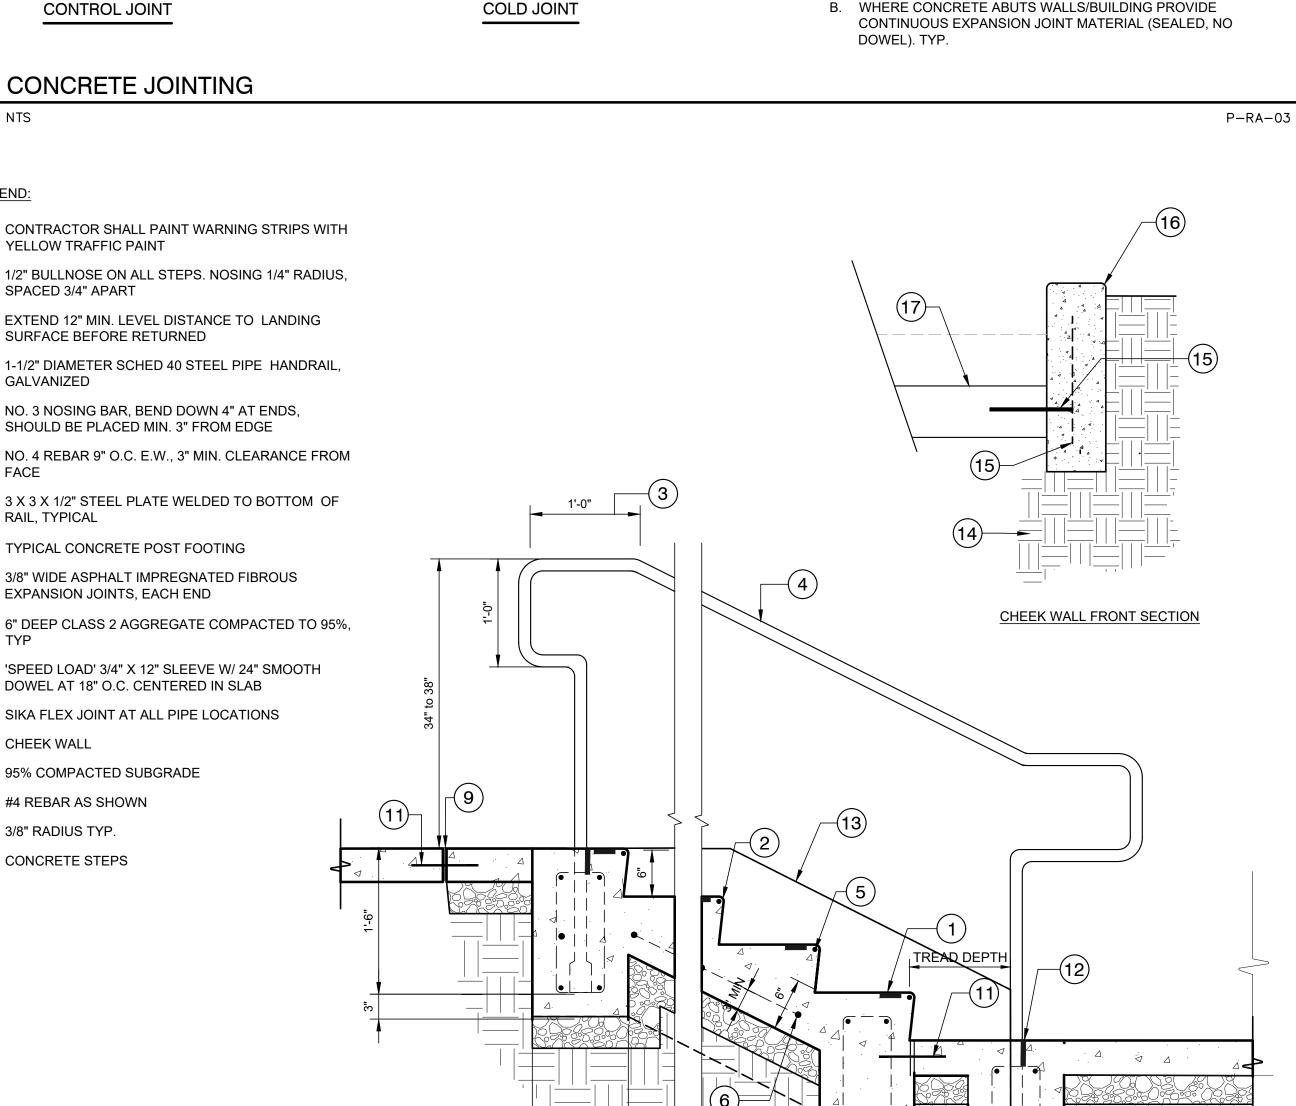
COATS COAL - TAR BASED WATER PROOFING TO PORTION

1'-6"

P-RA-05

Attachment 3 Page 10 of 19

10 OF 19 SHEETS



WATSONVILLE OF PARK CITY


FOR REDUCED PLANS ORIGINAL SCALE IS IN INCHES



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GRT CLASSIC SYSTEM



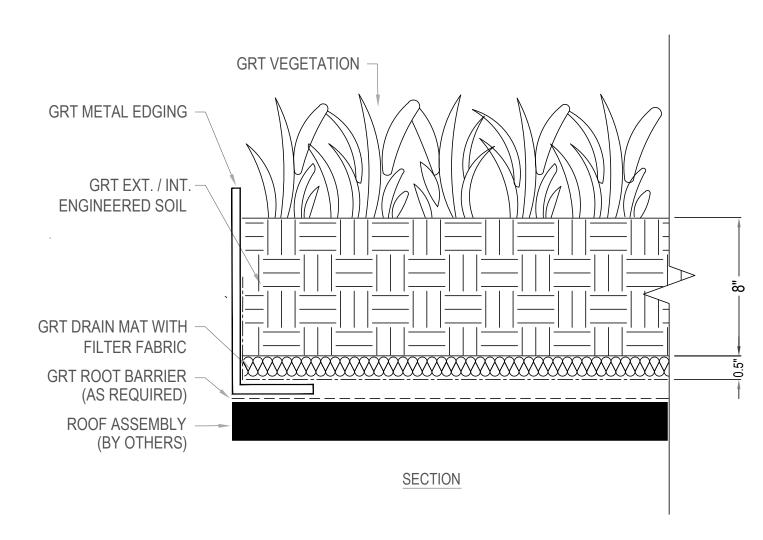1.INSTALLATION TO BE COMPLETED IN ACCORDANCE WITH MANUFACTURER'S SPECIFICATIONS.

2.DO NOT SCALE DRAWING. 3.THIS DRAWING IS INTENDED FOR USE BY ARCHITECTS, ENGINEERS, CONTRACTORS, CONSULTANTS AND DESIGN PROFESSIONALS FOR PLANNING PURPOSES ONLY. THIS DRAWING MAY NOT BE USED FOR CONSTRUCTION. 4.ALL INFORMATION CONTAINED HEREIN WAS CURRENT AT THE TIME OF DEVELOPMENT BUT MUST BE REVIEWED AND

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5.CONTRACTOR'S NOTE: FOR PRODUCT AND COMPANY INFORMATION VISIT WWW.GREENRISETECH.COM.



GRT LAYERED GREEN ROOF SYSTEM

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LEGEND:

LANDSCAPE ARCHITECT

2 COMPACTED SUBRADE

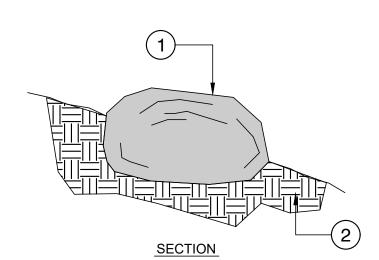
NOTES:

1) BOULDER, TO BE SELECTED BY A. DEPRESS BOULDER MASS 1/3 TO 1/2 BELOW GRADE AS SHOWN

B. SEE LANDSCAPE LAYOUT PLAN FOR LOCATIONS


C. BOULDER GROUPINGS SHALL BE VARYING SIZES, NOT LESS THAN 2' IN ANY EXPOSED DIMENSION

323020-08



BOULDER PLACEMENT ON SLOPE

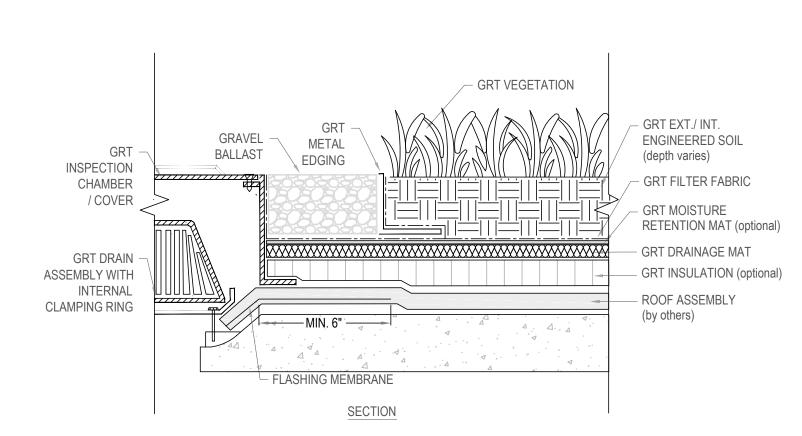NTS



1.INSTALLATION TO BE COMPLETED IN ACCORDANCE WITH MANUFACTURER'S SPECIFICATIONS.

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AT ROOF DRAIN

REVISION DATE 7/12/23

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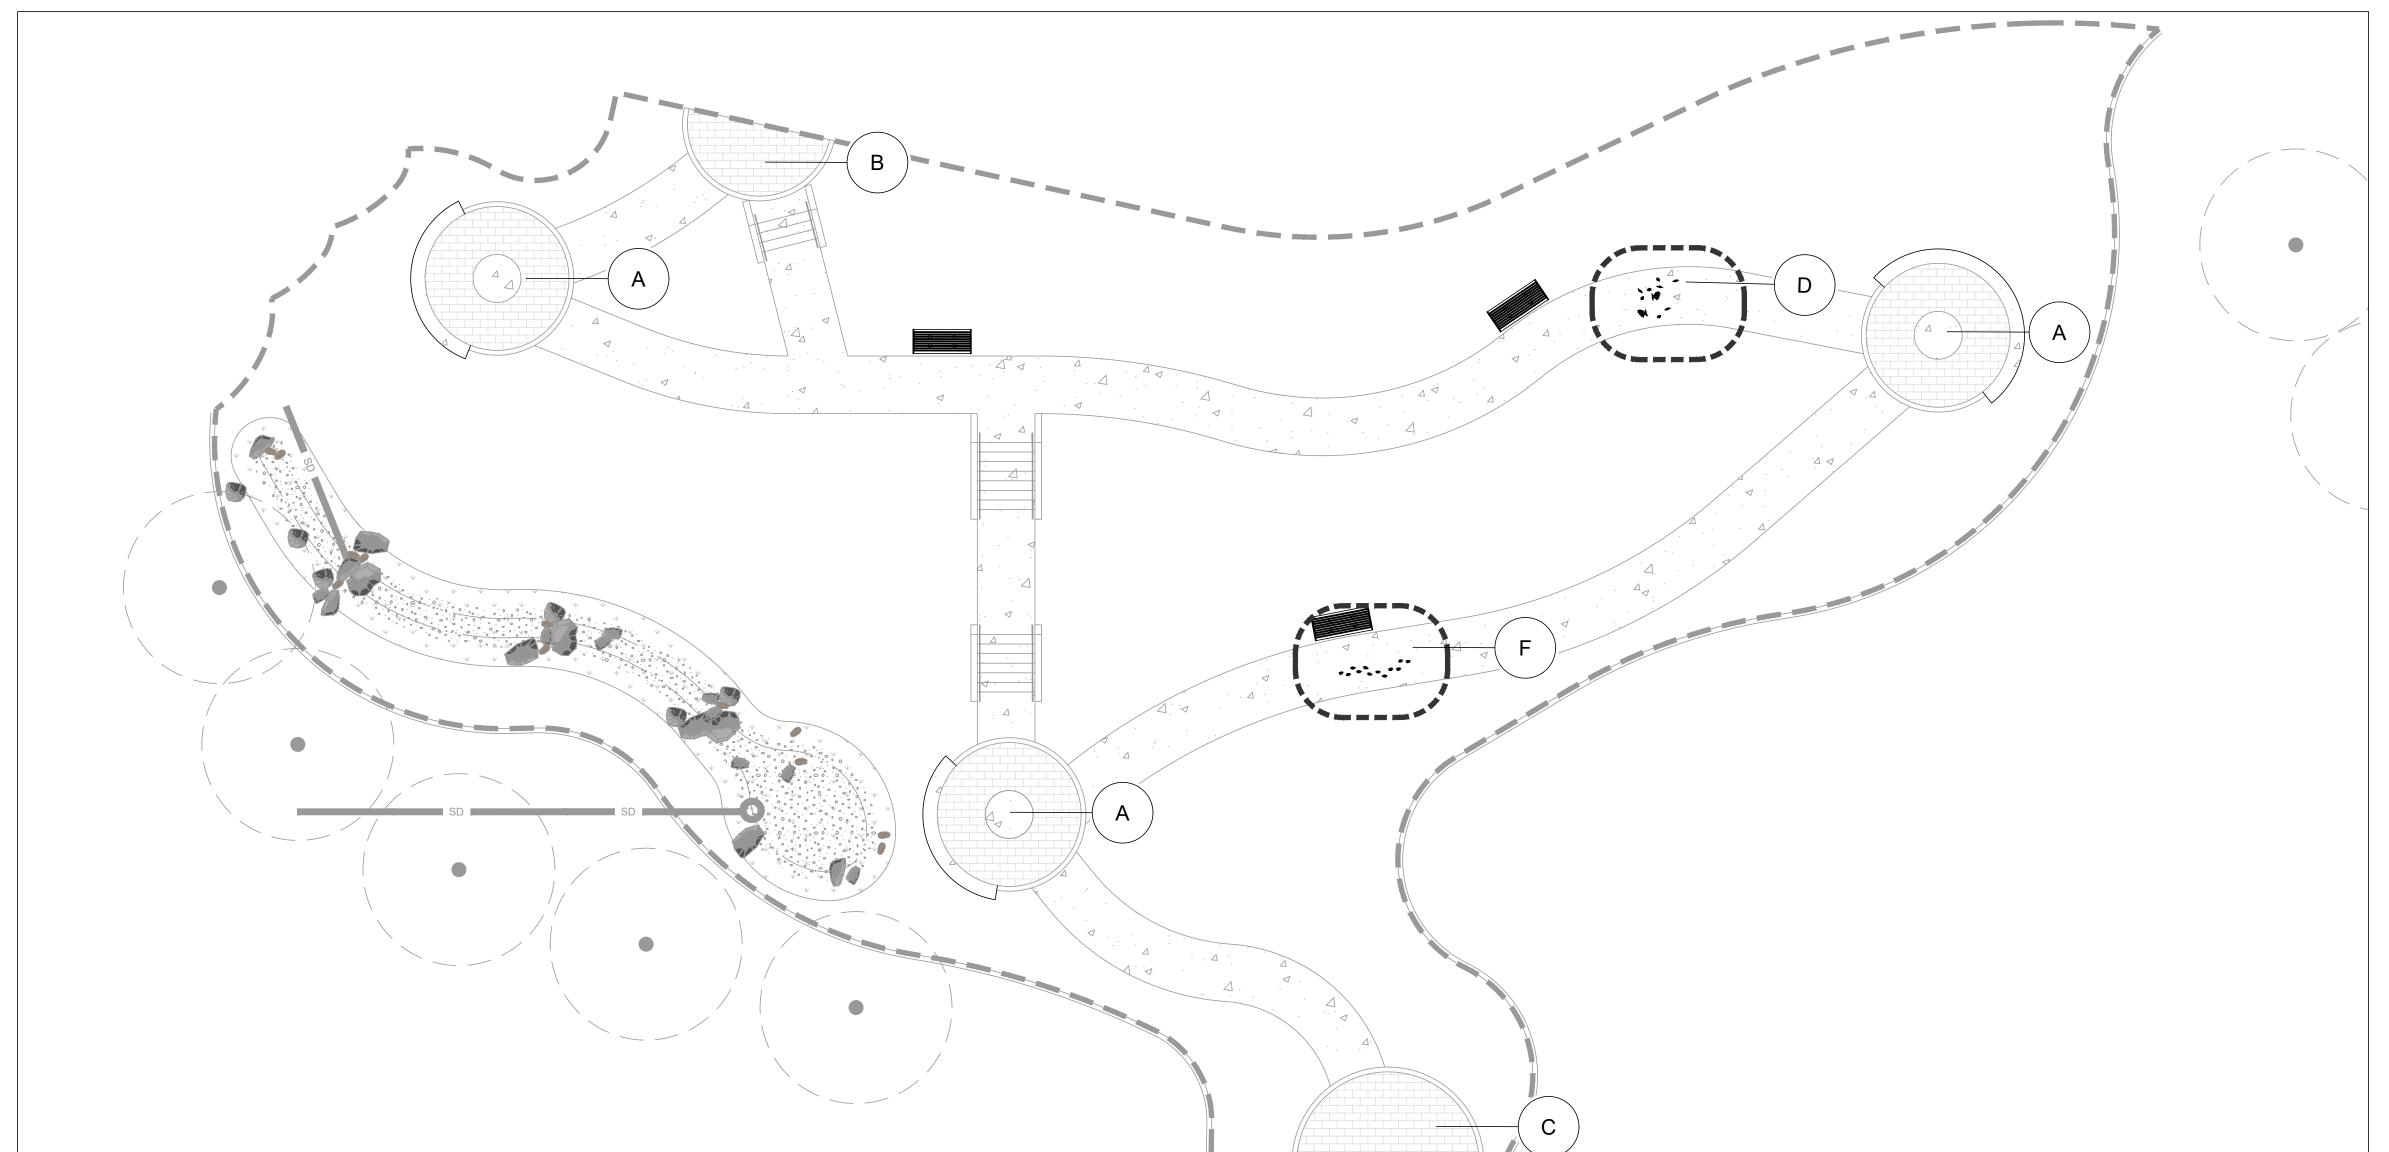
> GREEN INFRASTRUCTURE OF WATSONVILLE CITY

DESIGNERS: EAS/SLB DRAWN BY: MCC DATE: 07/09/24 DRAWING NO. LD-2

FILE NAME: 1535-0007-SITE-DETL.DWG Plot Date: 7/9/2024 ORIGINAL SCALE IS IN INCHES

ORIGINAL SCALE IS IN INCHES

2

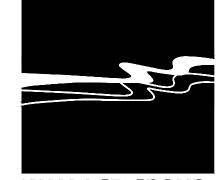


PAVER COLORS:

- 1. MAIN FIELD B5 MOHAVE DUNES
- 2. ACCENT: S5 CHARCOAL
- 3. 5' DIAMETER MOSAIC MEDALLION FIELD

NOTES:

- A. CONTRACTOR SHALL ACCOUNT FOR PAW PRINTS AND LEAF IMPRINTS FOR THE ENTIRE CONCRETE PATHWAY AND INCLUDE PRICING FOR THIS ITEM IN THE CONCRETE BID ITEM. PLANT AND ANIMAL SPECIES TO BE CHOSEN BY THE CITY. SEE SPECIFICATIONS.
- B. ABALONE CHIPS SHALL BE BROADCAST IN SPECIFIC LOCATIONS (IDENTIFIED BY CITY REPRESENTATIVE) FOR A TOTAL OF 10% OF PATH CONCRETE (APPROXIMATELY 200 SQUARE FEET).
- C. SPECIFIC LOCATIONS OF LEAVES AND ANIMAL PRINTS TO BE LOCATED IN THE FIELD BY CITY REPRESENTATIVE.
- D. PROVIDE A 4'X4' MOCK-UP SHOWING ALL REPRESENTATIVE IMPRINTS FOR REVIEW AND APPROVAL BY THE CITY BEFORE CONSTRUCTION. THIS MOCK-UP SHALL BE SEPARATE FROM THE WALKWAY.
- E. CONTRACTOR SHALL PROVIDE AN IN-PLACE MOCK-UP OF THE PAVERS FOR REVIEW AND APPROVAL PRIOR TO CONSTRUCTION. PROVIDE ONE (1) MOCK-UP FOR BOTH INTERMEDIATE LANDING AND ENTRY DESIGNS.
- F. MOSAIC MEDALLION TO BE PROVIDED BY CITY. CONTRACTOR SHALL INSTALL 5' DIAMETER CONCRETE PAD, 4" THICK. BASE MATERIAL TO FOLLOW CONCRETE DETAIL 7, SHEET C-4.0. CONTRACTOR SHALL ENSURE CONCRETE PAD IS SET $\frac{3}{4}$ " LOWER THAN SURROUNDING PAVERS TO ALLOW FOR MOSAIC INLAY.
- G. SEE PAVER DETAIL 6 ON SHEET C-4.0.
- H. SEE SPECIFICATIONS FOR MORE INFORMATION.




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CITY OF WATSONVILLE
RAMSAY PARK GREEN INFRASTRUCTURE

JOB #: 1535-0007

DESIGNERS: EAS/SLB

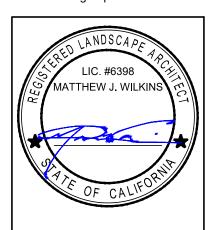DRAWN BY: MCC

DATE: 07/09/24

DRAWING NO.

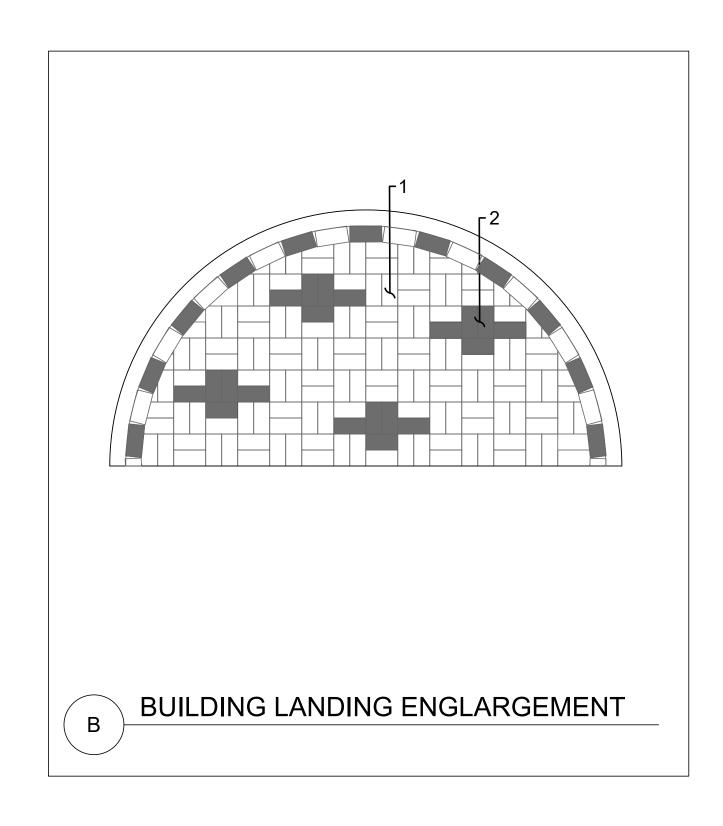
LD-3

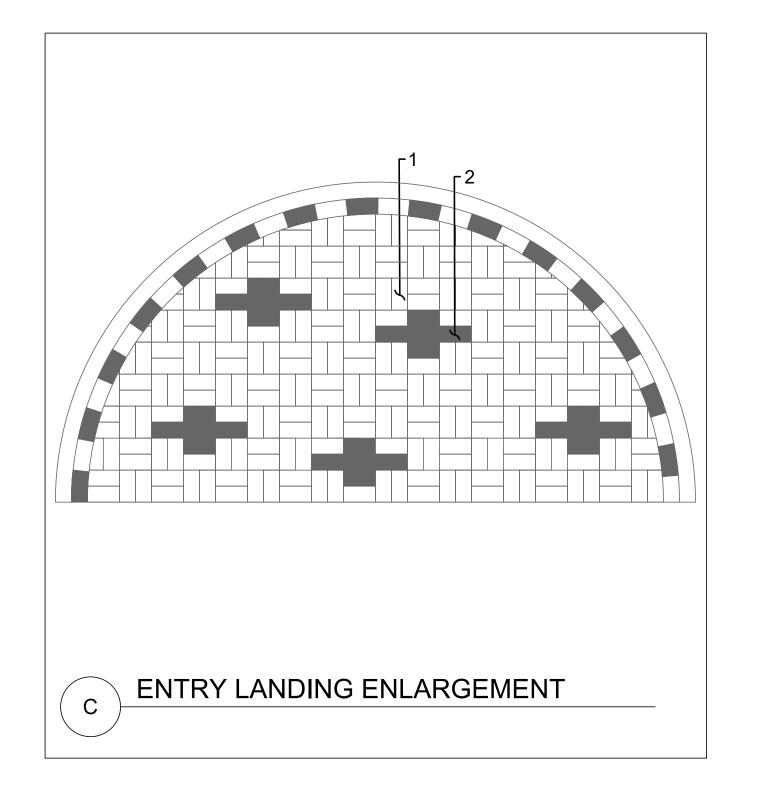
12 OF 19 SHEETS

SEATWALL

SEATWALL

PATHWAY LANDING PAVING ENLARGEMENT








STAMPED CONCRETE: ANIMAL PRINTS

1 DECORATIVE PAVERS AND ETCHED CONCRETE

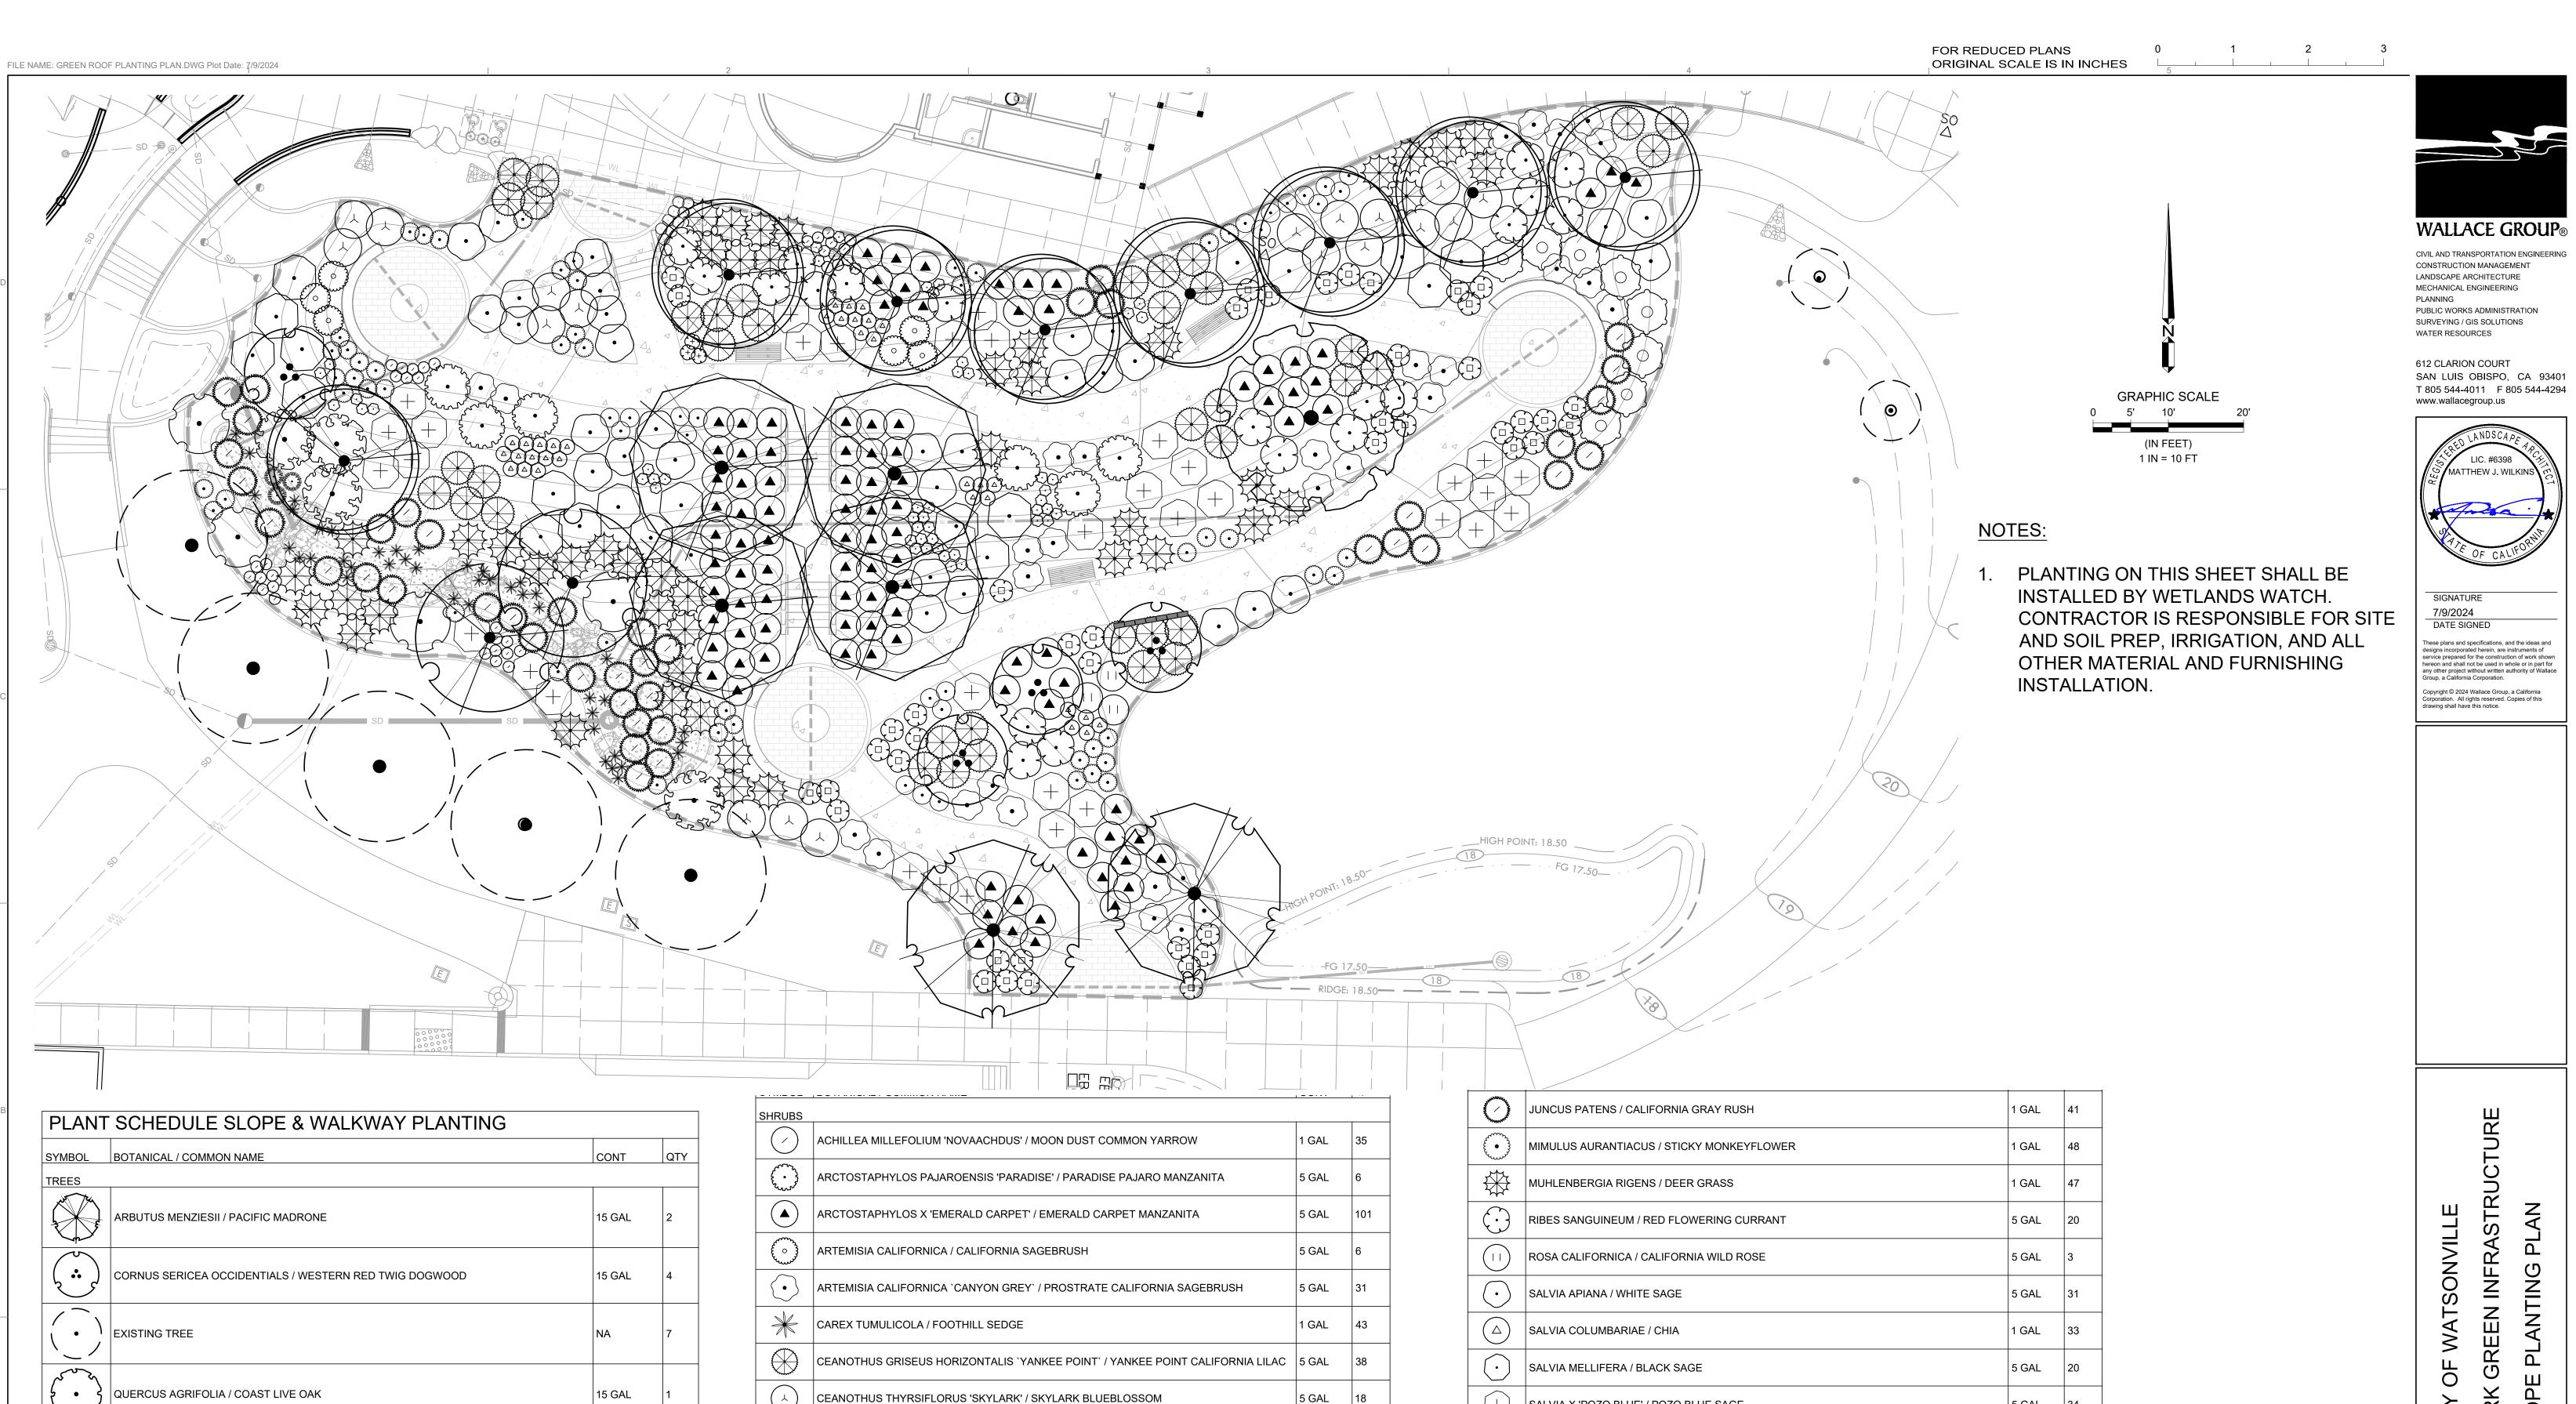SCALE: 1" = 3'-0"



ΟΙ ΔΝΙΤ		SHRUBS				
SYMBOL	SCHEDULE SLOPE & WALKWAY PLANTING BOTANICAL / COMMON NAME		\bigcirc	ACHILLEA MIL		
TREES						
	ARBUTUS MENZIESII / PACIFIC MADRONE	15 GAL	2		A	ARCTOSTAPH
						ARTEMISIA CA
الحن كم	CORNUS SERICEA OCCIDENTIALS / WESTERN RED TWIG DOGWOOD	15 GAL	4		•	ARTEMISIA CA
(.)	EXISTING TREE	NA	NA 7		*	CAREX TUMU
					\bigoplus	CEANOTHUS
\\\\\\\\\\\\\\\\\\\\\\\\\\\\\\\\\\\\\\	QUERCUS AGRIFOLIA / COAST LIVE OAK	15 GAL	1		$\langle \lambda \rangle$	CEANOTHUS '
	QUERCUS TOMENTELLA / ISLAND OAK	15 GAL	15 GAL 8		5 - 42 - 42 - 42 - 42 - 42 - 42 - 42 - 4	CORYLUS CO
					(+)	DUDLEYA BRI
3 5	QUERCUS TOMENTELLA / ISLAND OAK TWO (2) EXISTING TREES TO BE TRANSPLANTED FROM OTHER LOCATION IN PARK	EXISTING	2			ELYMUS GLAU
	UMBELLULARIA CALIFORNICA STD / BAY LAUREL 15					EPILOBIUM CA
		15 GAL	4		•	ERIGERON GL
						ESCUSCUOI 7

SHRUBS			
	ACHILLEA MILLEFOLIUM 'NOVAACHDUS' / MOON DUST COMMON YARROW	1 GAL	35
Server of the se	ARCTOSTAPHYLOS PAJAROENSIS 'PARADISE' / PARADISE PAJARO MANZANITA	5 GAL	6
(ARCTOSTAPHYLOS X 'EMERALD CARPET' / EMERALD CARPET MANZANITA	5 GAL	101
(°)	ARTEMISIA CALIFORNICA / CALIFORNIA SAGEBRUSH	5 GAL	6
•	ARTEMISIA CALIFORNICA `CANYON GREY` / PROSTRATE CALIFORNIA SAGEBRUSH	5 GAL	31
*	CAREX TUMULICOLA / FOOTHILL SEDGE	1 GAL	43
\bigoplus	CEANOTHUS GRISEUS HORIZONTALIS 'YANKEE POINT' / YANKEE POINT CALIFORNIA LILAC	5 GAL	38
$\langle \cdot \rangle$	CEANOTHUS THYRSIFLORUS 'SKYLARK' / SKYLARK BLUEBLOSSOM	5 GAL	18
2. 2. 2. 2. 2. 2. 2. 2. 2. 2. 2. 2. 2. 2	CORYLUS CORNUTA CALIFORNICA / WESTERN HAZELNUT	15 GAL	4
(+)	DUDLEYA BRITTONII / GIANT CHALK DUDLEYA	1 GAL	3
	ELYMUS GLAUCUS / BLUE WILDRYE	1 GAL	3
	EPILOBIUM CANUM / CALIFORNIA FUCHSIA	1 GAL	45
•	ERIGERON GLAUCUS / SEASIDE DAISY	1 GAL	21
\bigcirc	ESCHSCHOLZIA CALIFORNICA / CALIFORNIA POPPY	1 GAL	50
\bigcirc	FRANGULA CALIFORNICA `MOUND SAN BRUNO` / MOUND SAN BRUNO COFFEEBERRY	5 GAL	8
$\overline{}$	IRIS DOUGLASIANA PCH 'CANYON SNOW' / CANYON SNOW IRIS	1 GAL	11
	1	1	

	THE PARTY OF THE P	JUNCUS PATENS / CALIFORNIA GRAY RUSH	1 GAL	41
	£	MIMULUS AURANTIACUS / STICKY MONKEYFLOWER	1 GAL	48
	***	MUHLENBERGIA RIGENS / DEER GRASS	1 GAL	47
	\bigcirc	RIBES SANGUINEUM / RED FLOWERING CURRANT	5 GAL	20
		ROSA CALIFORNICA / CALIFORNIA WILD ROSE	5 GAL	3
	\odot	SALVIA APIANA / WHITE SAGE	5 GAL	31
	\triangle	SALVIA COLUMBARIAE / CHIA	1 GAL	33
	\odot	SALVIA MELLIFERA / BLACK SAGE	5 GAL	20
	+	SALVIA X 'POZO BLUE' / POZO BLUE SAGE	5 GAL	34
	$\langle \cdot \rangle$	SAMBUCUS MEXICANA / MEXICAN ELDERBERRY	5 GAL	4

– – ROOT BARRIER

PARK GREEN INFRASTRUCTURE CITY

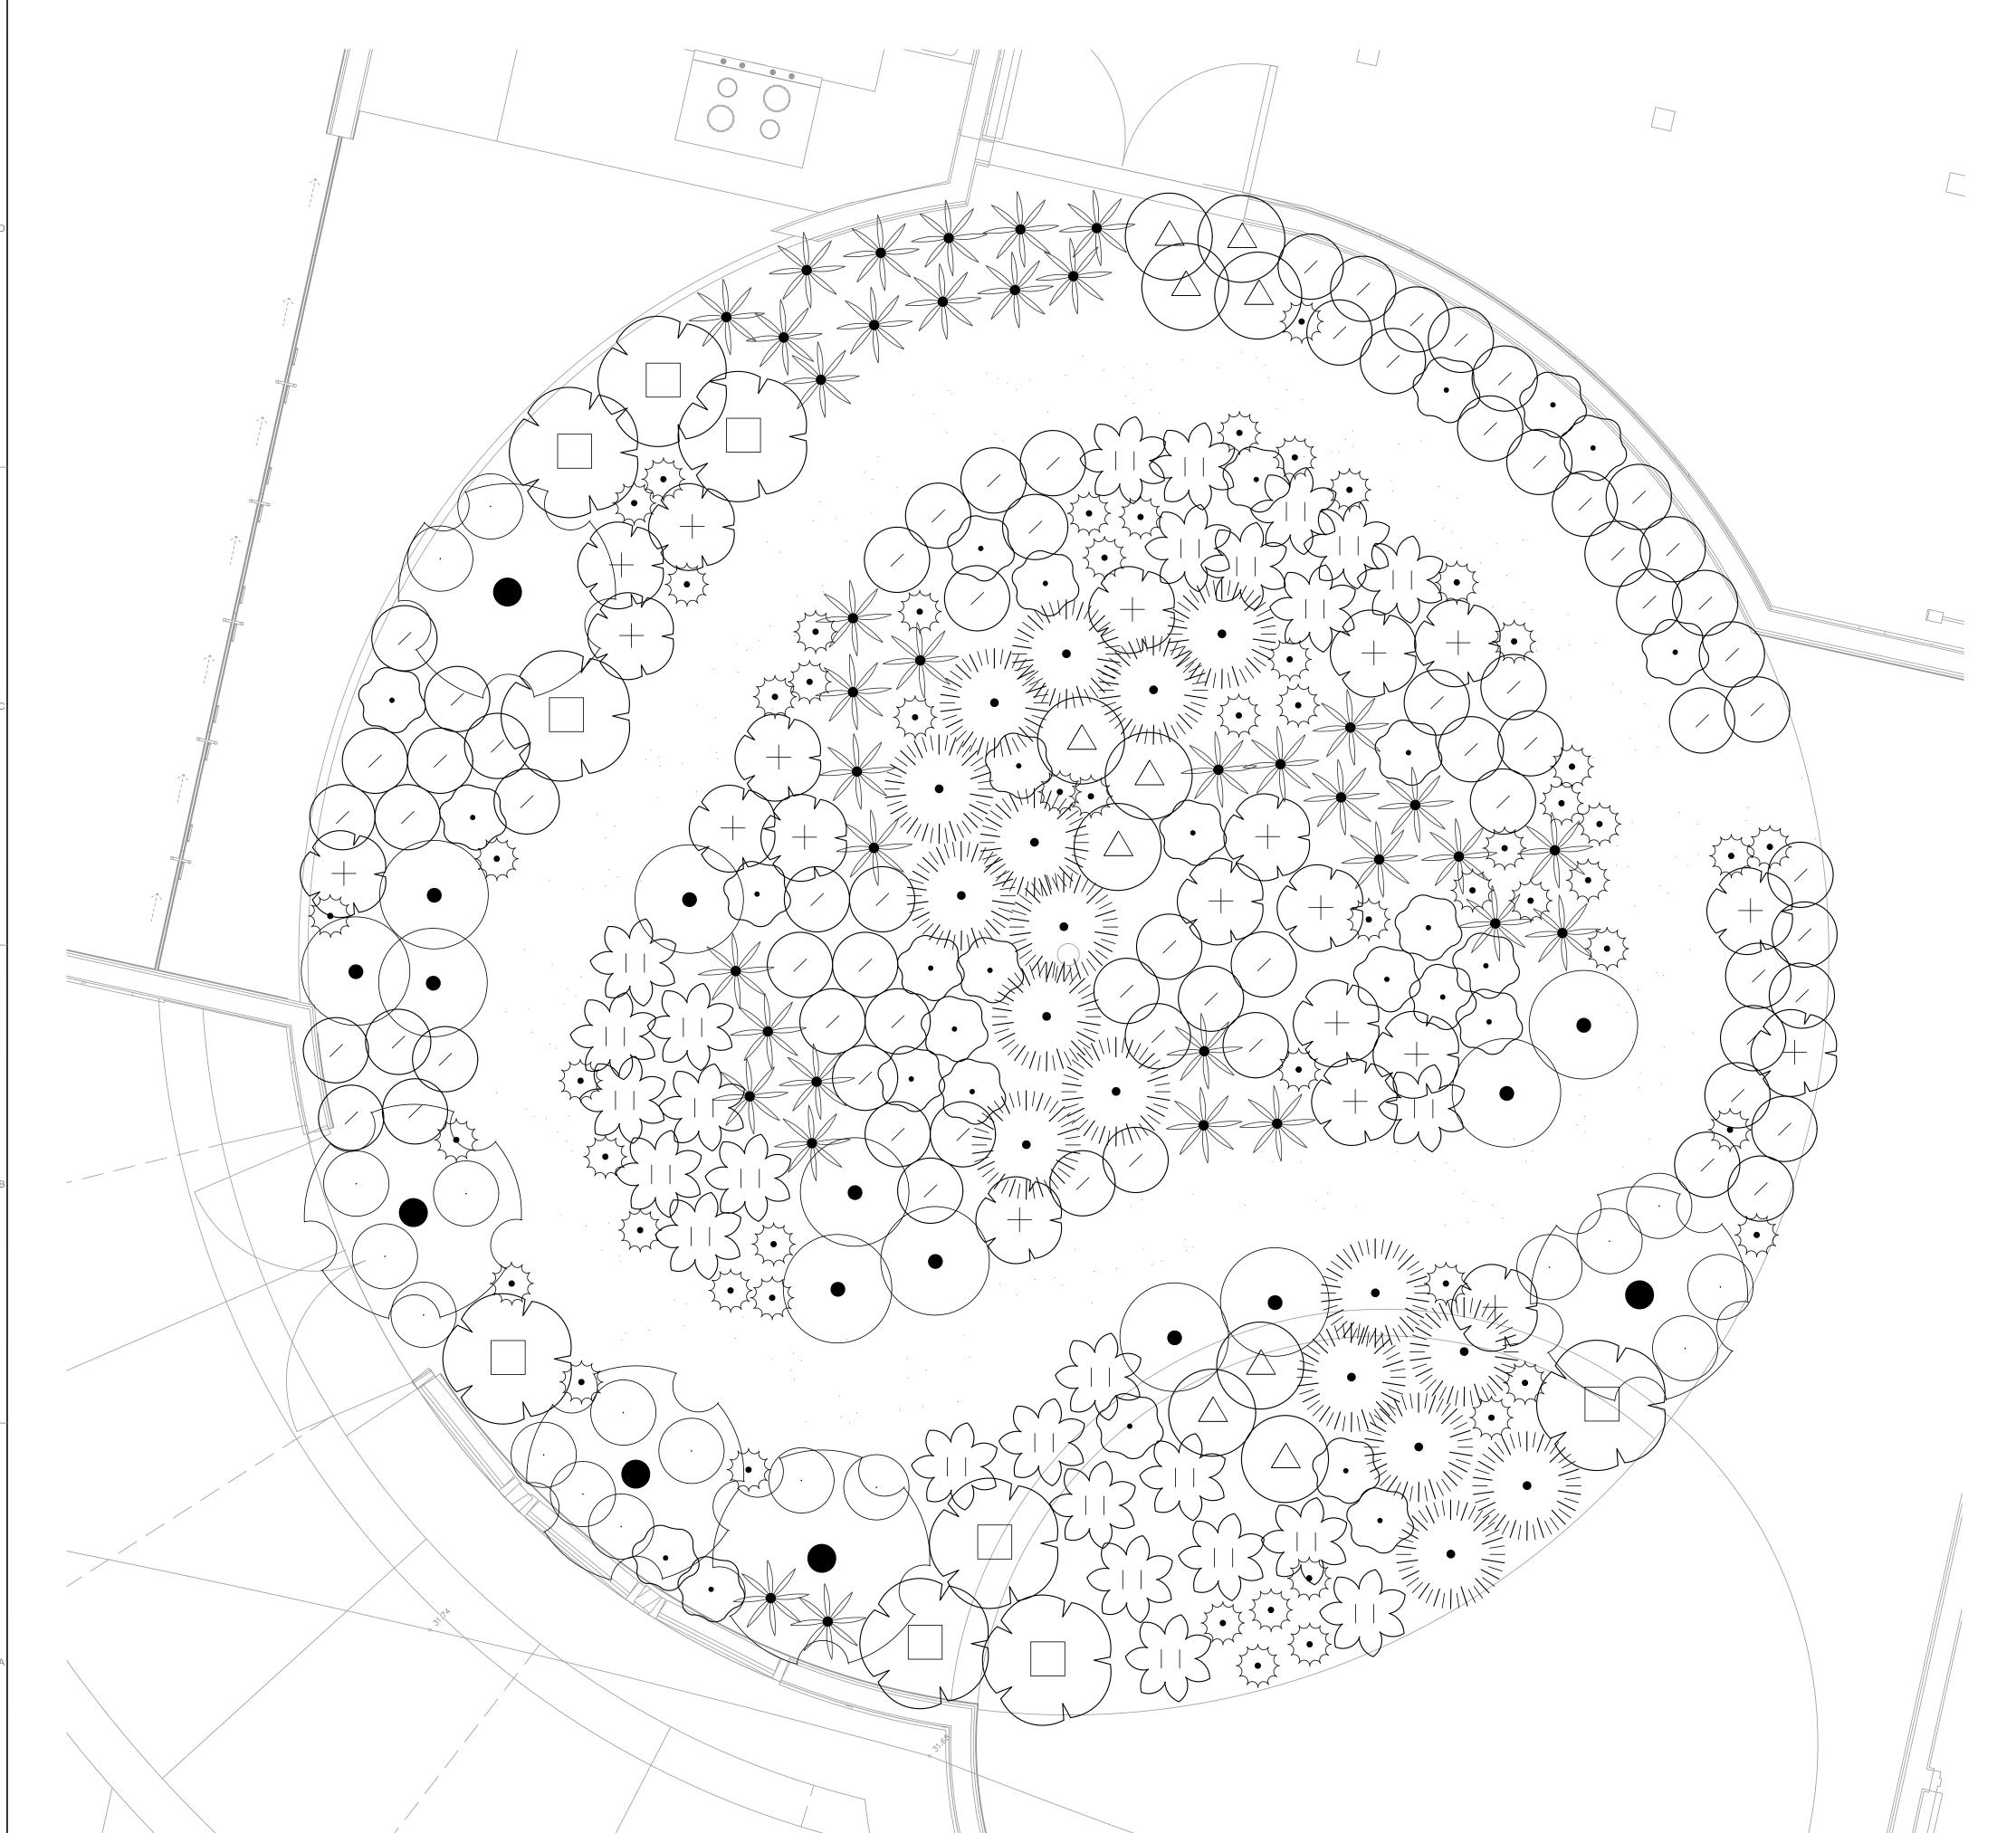
DESIGNERS: SLB DRAWN BY: MCC DRAWING NO. PL-1

FOR REDUCED PLANS

ORIGINAL SCALE IS IN INCHES

ORIGINAL SCALE IS IN INCHES


3



SYMBOL	BOTANICAL / COMMON NAME	CONT	QTY
SHRUBS		1	
$\langle \rangle$	ACHILLEA MILLEFOLIUM 'NOVAACHDUS' / MOON DUST COMMON YARROW	1 GAL	69
£13	CAREX TEXENSIS / TEXAS SEDGE	1 GAL	27
*	CAREX TUMULICOLA / FOOTHILL SEDGE	1 GAL	37
(+)	DUDLEYA BRITTONII / GIANT CHALK DUDLEYA	1 GAL	20
	ELYMUS GLAUCUS / BLUE WILDRYE	1 GAL	17
	EPILOBIUM CANUM / CALIFORNIA FUCHSIA	1 GAL	9
•	ERIGERON GLAUCUS / SEASIDE DAISY	1 GAL	11
\odot	ESCHSCHOLZIA CALIFORNICA / CALIFORNIA POPPY	1 GAL	28
$\overline{}$	IRIS DOUGLASIANA PCH 'CANYON SNOW' / CANYON SNOW IRIS	1 GAL	18
•	SALVIA APIANA / WHITE SAGE	1 GAL	5
\triangle	SALVIA COLUMBARIAE / CHIA	1 GAL	10
	SISYRINCHIUM BELLUM / BLUE-EYED GRASS	1 GAL	56

NOTES:

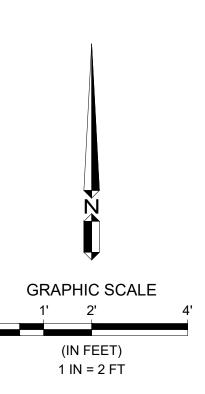- 1. SOIL MEDIUM TO BE A LIGHT WEIGHT GREEN ROOF SOIL BLEND MIX. SEE SPECIFICATIONS.
- 2. MULCH AROUND PLANTS WITH $\frac{3}{4}$ " CRUSHED GRAVEL, 2" DEEP.
- 3. GRAVEL PATH TO BE $\frac{3}{4}$ " CRUSHED GRAVEL, 3" DEEP.
- 4. PEDESTRIAN TRAFFIC OVER THE WORKING AREA SHALL BE RESTRICTED AND CONTROLLED TO QUALIFIED PERSONNEL ONLY.
- 5. PRIOR TO INSTALLATION OF GREEN ROOF COMPONENTS, INSPECT THE SUBSTRATE. IT MUST BE CLEAN AND FREE OF PROJECTIONS AND DEBRIS THAT COULD IMPAIR THE PERFORMANCE OF THE INSTALLATION.
- 6. THE TOTAL DEPTH OF ROOF SOIL AND CRUSHED GRAVEL IS 8-INCHES. CARE MUST BE TAKEN TO AVOID USE OF SHARP TOOLS THAT MAY COME IN CONTACT WITH THE ROOF WATERPROOFING SUBSTRATE. USE SHORT HAND TOOLS ONLY. SHOVELS AND OTHER LONG HANDLED TOOLS ARE PROHIBITED ON THE GREEN ROOF EXCEPT FOR RAKES TO AID IN SPREADING THE SOIL MEDIA OR CRUSHED GRAVEL.






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CITY OF WATSONVILLE
PARK GREEN INFRASTRUCTURE

JOB #: 1535-0007

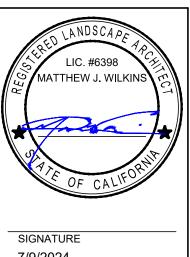DESIGNERS: SLB

DRAWN BY: MCC

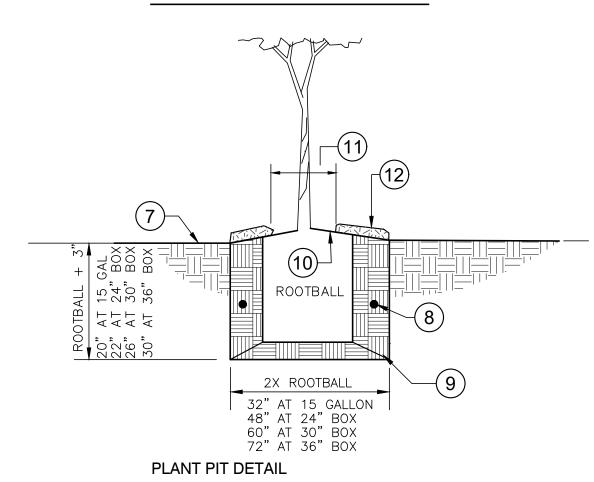
DATE: 07/09/24

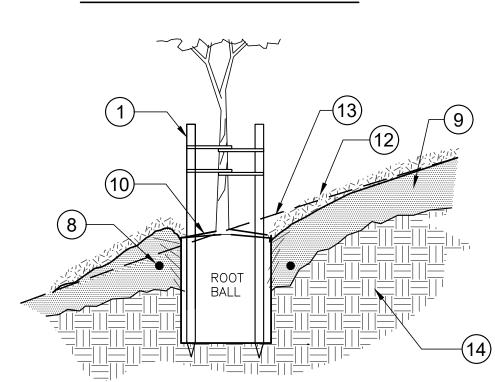
DRAWING NO.

PL-2

14 OF 19 SHEETS

STAKING DETAIL





TREE ON SLOPE DETAIL

(1) (3)- 2" DIA. LODGEPOLE PINE STAKE OUTSIDE ROOTBALL. CUT STAKE 2" BELOW LOWEST BRANCH AND INSTALL IN LINE WITH PREVAILING WINDS.

(2) (3)- SETS OF REINFORCED RUBBER TIRE TREE STRAPS, TIED IN A FIGURE 8 STYLE. NAILS FLUSH TO STAKE SURFACE AND SECURED AT LOWEST POINT NECESSARY TO HOLD TUBE UPRIGHT.

(3) REMOVE NURSERY STAKES

(4) 1X3 CROSSTIE, AVOID RUBBING INJURY TO TRUNK

(5) BACKFILL MIX, SEE NOTES

(6) AVOID DAMAGE TO THE ROOT BALL WITH THE SUPPORT STAKES

(7) FINISHED GRADE

(8) PLANT TABLETS PLACED 1" FROM ROOTBALL 1/3 DEPTH OF PLANT PIT - SEE

(9) BACKFILL MIX, SEE NOTES.

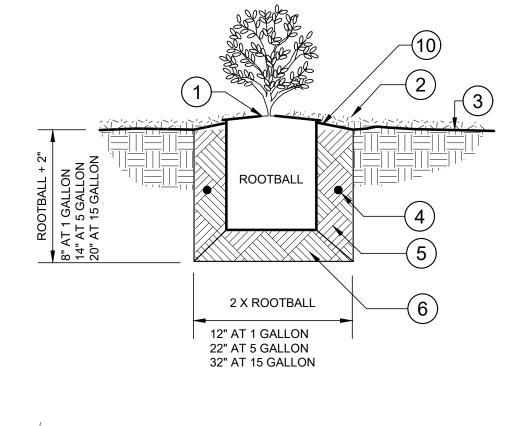
(10) SET ROOTBALL CROWN 1-1/2" HIGHER THAN THE SURROUNDING FINISHED GRADE. SLOPE BACKFILL AWAY FROM ROOTBALL FOR POSITIVE DRAINAGE

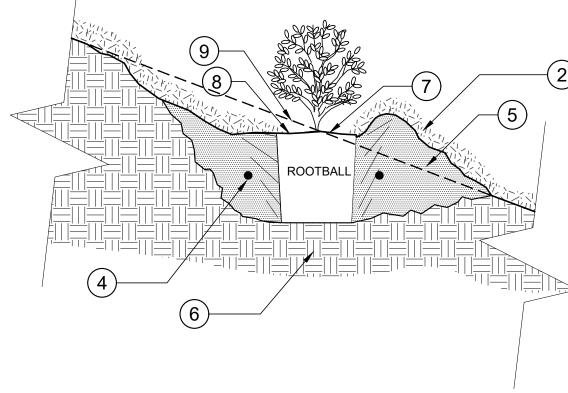
(11) KEEP BARK MULCH 6"-8" FROM BASE OF TREE

(12) BARK MULCH - 3" DEPTH WHERE NOTED ON PLANS.

(13) ORIGINAL SLOPE SHOULD PASS THROUGH THE POINT WHERE THE TRUNK MEETS SUBSTRATE/SOIL.

(14) UNDISTURBED EXISTING SOIL.





(1) SET ROOTBALL CROWN 1" HIGHER THAN SURROUNDING FINISHED GRADE

(2) BARK MULCH - 3" DEPTH WHERE NOTED ON PLANS.

(4) PLANT TABLETS 1/3 THE DEPTH OF ROOTBALL, SEE NOTES.

(5) BACKFILL MIX, SEE NOTES.

(6) UNDISTURBED EXISTING SOIL

(7) SET ROOTBALL CROWN 1-1/2" HIGHER THAN THE SURROUNGING FINISHED GRADE. SLOPE BACKFILL AWAY FROM ROOTBALL FOR POSITIVE DRAINAGE

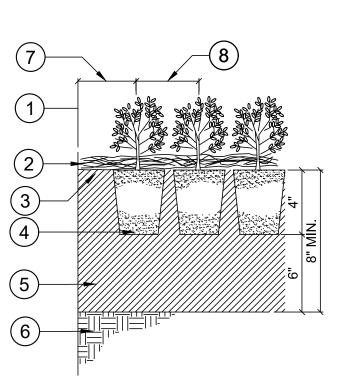
(8) KEEP BARK MULCH 6-8" FROM BASE OF SHRUB.

(9) ORIGINAL SLOPE SHOULD PASS THROUGH THE POINT WHERE THE TRUNK MEETS

(10) SLOPE FINISHED GRADE AT BACKFILL AWAY FROM ROOTBALL

SHRUB PLANTING

P-RA-09



LEGEND:

(1) EDGE OF PLANTING

(2) 3" DEPTH OF BARK MULCH

(3) FINISH GRADE

(4) PLANTS FROM POTS OF LINERS AS REQUIRED

(5) BACKFILL MIX, SEE NOTES & SOILS REPORT

(6) EXISTING SOIL

(7) 2/3 PLAN SPACING (8) SPACING PER PLANS

NOTES: A. PREPARE FINISH GRADE OF BEDS TO SURFACE DRAIN AWAY FROM

WALLS / STRUCTURES

P-RA-08

GROUND COVER BED PLANTING

329313.13-01

GREEN ROOF WEIGHT TABLE

IATERIAL NAME	POUNDS PER SQUARE FOOT			
GREEN ROOF SYSTEM (SATURATED)	58			
CRUSHED GRAVEL 2" DEEP	14			
PLANT MATERIAL	1			
TOTAL	73			

GREEN ROOF NOTE:

1. THE ROOF DESIGN FROM THE NATURE CENTER PLANS ALLOWS

FOR A WEIGHT OF 80 POUNDS PER SQUARE FOOT (PSF). 2. WEIGHT TABLE IS A CALCULATION OF THE MOST PREVALENT CONDITION (THE PLANTED AREA). THE PATHWAY HAS 3" OF CRUSHED GRAVEL AND NO PLANTS, ITS TOTAL WEIGHT IS

CALCULATED AT 72 POUNDS PER SQUARE FOOT. 3. CONTRACTOR SHALL ENSURE THAT THE WEIGHT OF THE ROOFTOP DOESN'T EXCEED 80 PSF DURING THE INSTALLATION PROCESS. CONTRACTOR SHALL SUBMIT DESIRED INSTALLATION MATERIALS. METHODS, AND PERSONNEL FOR REVIEW BY OWNER REPRESENTATIVE PRIOR TO INSTALLATION. FINAL INSTALLED

DESIGN SHALL NOT EXCEED 80PSF. 4. IT IS THE SOLE RESPONSIBILITY OF THE CONTRACTOR TO ENSURE THAT THE WATERPROOFING OF THE ROOF IS IN TACT AND NOT DAMAGED DURING THE INSTALLATION OF THE GREENROOF PLANTING AND IRRIGATION. CONTRACTOR SHALL CONFIRM THAT WATERPROOFING OF ROOF IS IN PLACE PRIOR TO INSTALLATION OF THE GREENROOF AND BRING ANY ISSUES OR CONCERNS TO THE IMMEDIATE ATTENTION OF THE OWNER REPRESENTATIVE.

DESIGN OF THE GREENROOF IS LIMITED TO PLANTING AND IRRIGATION ONLY, THE WORK HEREIN THESE DOCUMENTS DO NOT PERTAIN TO THE WATERPROOFING, BUILDING WATER LINES, AND OTHER MATERIALS THAT ARE NOT SHOWN IN THESE DRAWINGS.

PLANTING NOTES:

- 1. REFER TO PLANTING PLANS, PLAN NOTES, SPECIFICATIONS, PLANT LEGEND, AND PLANTING DETAILS FOR ADDITIONAL PLANTING INFORMATION. REFER TO IRRIGATION PLANS, NOTES, SPECIFICATIONS, AND DETAILS FOR RELATED LANDSCAPE WORK.
- 2. NOTIFY OWNER'S REPRESENTATIVE (REP.) 48 HOURS MINIMUM PRIOR TO COMMENCEMENT OF WORK TO COORDINATE PROJECT INSPECTION SCHEDULE.
- 3. VERIFY ALL EXISTING CONDITIONS, DIMENSIONS AND ELEVATIONS BEFORE PROCEEDING WITH THE WORK. IMMEDIATELY NOTIFY OWNER'S REPRESENTATIVE OF FIELD CONDITIONS THAT VARY FROM THOSE SHOWN ON DRAWINGS AND SEEK CORRECTIONS AND DIRECTIONS BEFORE PROCEEDING WITH WORK. ASSUME FULL RESPONSIBILITY FOR ALL NECESSARY CORRECTIONS DUE TO FAILURE TO REPORT KNOWN DISCREPANCIES.
- 4. LOCATE AND MARK ALL EXISTING UTILITIES WHETHER SHOWN HEREON OR NOT PROTECT FROM DAMAGE ALL UTILITIES, AREAS AND STRUCTURES IN AND AROUND LANDSCAPE WORK AREAS. ASSUME FULL RESPONSIBILITY AND EXPENSE FOR REPAIR AND REPLACEMENT OF DAMAGES CAUSED BY CONTRACTOR.
- 5. LOCATION OF NON-LANDSCAPE CONSTRUCTION ELEMENTS SUCH AS LIGHTS, SIGNS, VENTS, HYDRANTS, TRANSFORMERS, AND OTHER STRUCTURES OR ELEMENTS ARE APPROXIMATE. CONTRACTOR SHALL VERIFY FIELD CONDITIONS WHETHER SHOWN HEREON OR NOT. WHEN SHOWN ITEMS DO NOT CORRESPOND TO FIELD CONDITIONS, REPORT DISCREPANCIES TO OWNER'S REP. FOR CLARIFICATIONS AND INSTRUCTIONS PRIOR TO PROCEEDING WITH WORK.
- 6. PLANTING ACCESSORIES & MATERIAL:
- A. TREE TIE: CINCH TIE, BY V.I.T. PRODUCTS, 800-729-1314. B. FERTILIZER TABLETS: AGRIFORM (OR APPROVED EQUAL) 20-10-5, THREE 20-GRAM TABLETS FOR 15 GALLON OR LARGER SIZE TREES, TWO 10-GRAM TABLETS FOR 5 GALLON SIZE PLANTS, ONE 10-GRAM TABLET FOR 1 GALLON

D. TOPSOIL (BACKFILL MIX): 60-70% LOAM TOPSOIL THOROUGHLY MIXED WITH

- C. ROOT BARRIER: 18" DEEP X 10' INJECTION MOLDED CO-POLYMER POLYPROPYLENE ROOT BARRIER PANELS
- 30-40% FULLY COMPOSTED ORGANIC MATERIAL E. MULCH: CONIFEROUS BARK MULCH AT SHRUB ONLY LOCATIONS WHERE NO COARSE GRAVEL OR RIVER COBBLE IS SHOWN. SUBMIT SAMPLE FOR
- 7. SOIL MANAGEMENT REPORT: PRIOR TO DELIVERING TOPSOIL TO PROJECT SITE, PROVIDE ONE REPRESENTATIVE SOIL SAMPLE OF THE TOPSOIL IN ACCORDANCE WITH LABORATORY PROTOCOL. SOIL ANALYSIS TO INCLUDE:
- A. SOIL TEXTURE B. INFILTRATION RATE

APPROVAL.

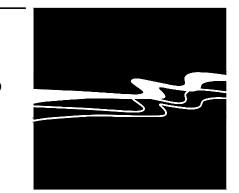
- D. TOTAL SOLUBLE SALTS
- E. SODIUM
- F. PERCENT ORGANIC MATTER G. RECOMMENDATIONS FOR TREE, SHRUB AND SOD PLANTING.

STRUCTURES PROVIDED BY OTHERS.

- 8. ADD FERTILIZER AND AMENDMENTS TO THE TOPSOIL PER SOIL TEST REPORT
- RECOMMENDATIONS FOR PLANTING WORK
- 9. PREPLANTING PREPARATION:
 - A. PROCEED WITH PLANTING WORK ONLY AFTER IRRIGATION WORK IS COMPLETED, TESTED, AND APPROVED BY OWNER'S REP. PROTECT IRRIGATION SYSTEM FROM DAMAGE.
- B. PLACE IMPORTED TOPSOIL IN AREAS SHOWN ON THE TOPSOIL PLAN TO THE DEPTH INDICATED. ROUGH GRADE PLANTING AREAS UNIFORMLY SMOOTH, DEVOID OF DEPRESSIONS, TO CONFORM TO THE GRADING PATTERNS ESTABLISHED BY CIVIL ENGINEERING DRAWINGS. ENSURE POSITIVE WATER REMOVAL AT 2% MINIMUM GRADIENT TO DRAINAGE ELEMENTS OR
- C. REMOVE ALL ROCKS GREATER THAN 1" DIAMETER AND ALL DEBRIS AND DELETERIOUS MATERIAL FROM PLANTING AREAS.
- 10. PLANTS: ALL PLANTS OF THE SAME SPECIES/CULTIVAR/VARIETY SHALL HAVE MATCHING FORM, FLOWER COLOR, AND SIZE, IN HEALTHY AND THRIVING CONDITION, FREE FROM INJURIES, DISEASES, PESTS AND ROOT-BOUND OR GIRDLING ROOTS. REPLACE REJECTED PLANTS WITH MATCHING SPECIES, SIZE AND FORM.

11. PLANTING:

- A. IRRIGATE PLANTING AREAS TO BRING TOP 6" OF SOIL TO FIELD CAPACITY. ALLOW SOIL TO DRAIN. DO NOT WORK SOIL UNTIL IT RETURNS TO A MOIST FRIABLE CONDITION. TREE EXCAVATIONS MAY REQUIRE ADDITIONAL
- IRRIGATION. FLOOD TREE PITS AS REQUIRED TO MOISTEN SUBGRADE. B. PLACE PLANTS IN THEIR CONTAINERS AT THE LOCATIONS PER PLANS FOR APPROVAL BY OWNER'S REP. MAKE MINOR ADJUSTMENTS AS REQUIRED BY FIELD CONDITIONS AND TO ALLOW OPTIMAL IRRIGATION COVERAGE.
- C. PLANT QUANTITIES GIVEN ON PLANT LEGEND ARE FOR GENERAL GUIDANCE ONLY. PROVIDE THE SPECIFIED PLANT SPECIES IN THE QUANTITIES AT THE REQUIRED SPACING TO ACHIEVE THE DESIGN EFFECT/INTENT SHOWN ON THE D. FOR TREES IN TREE WELLS OR WITHIN 6 FEET OF PAVEMENT AND SLAB
- FOUNDATIONS, PRIOR TO TREE PLACEMENT, INSTALL ROOT BARRIER PANELS ALL AROUND THE PLANT PIT PER THE MANUFACTURERS INSTALLATION INSTRUCTIONS AND DETAIL 4, THIS SHEET. LOCATIONS OF ROOT BARRIERS NOT SHOWN ON PLANS.
- E. PLANT TREES AND SHRUBS AS SHOWN ON DETAILS. F. INSTALL 3" DEEP CONIFEROUS BARK MULCH TO COVER BARE SOIL AROUND
- TREES & SHRUBS. KEEP MULCH 3" AWAY FROM SHRUB TRUNKS, 6-8" AWAY FROM TREE TRUNKS. DO NOT INSTALL CONIFEROUS BARK MULCH WHERE MINERAL MULCHES (COARSE GRAVEL / RIVER COBBLE) OCCUR.
- 12. 3-YEAR MAINTENANCE PERIOD: MAINTAIN PLANTINGS IN THRIVING CONDITION USING ACCEPTED INDUSTRY PRACTICES FOR WATERING, FERTILIZING, AND PRUNING. DO NOT MOW BIOFILTRATION SOD. MAINTAIN TREE STAKES IN PROPER POSITIONS. REMOVE TREE STAKES AT END OF MAINTENANCE PERIOD. REPLACE PLANTS THAT DIE OR FAIL TO ESTABLISH IN THRIVING CONDITION WITH SPECIES, SIZE AND FORM MATCHING OTHERS ON SITE. REPAIR OR REPLACE BROKEN IRRIGATION COMPONENTS.
- 13. WARRANTY: WARRANT PLANT MATERIAL AND IRRIGATION SYSTEM FOR ONE YEAR FROM END OF MAINTENANCE PERIOD. REPLACE DEAD OR DYING PLANTS AND BROKEN IRRIGATION COMPONENTS WITHIN THIS PERIOD.



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WATER RESOURCES



SIGNATURE 7/9/2024

DATE SIGNED These plans and specifications, and the ideas and lesigns incorporated herein, are instruments of service prepared for the construction of work shown hereon and shall not be used in whole or in part for any other project without written authority of Wallac Group, a California Corporation.

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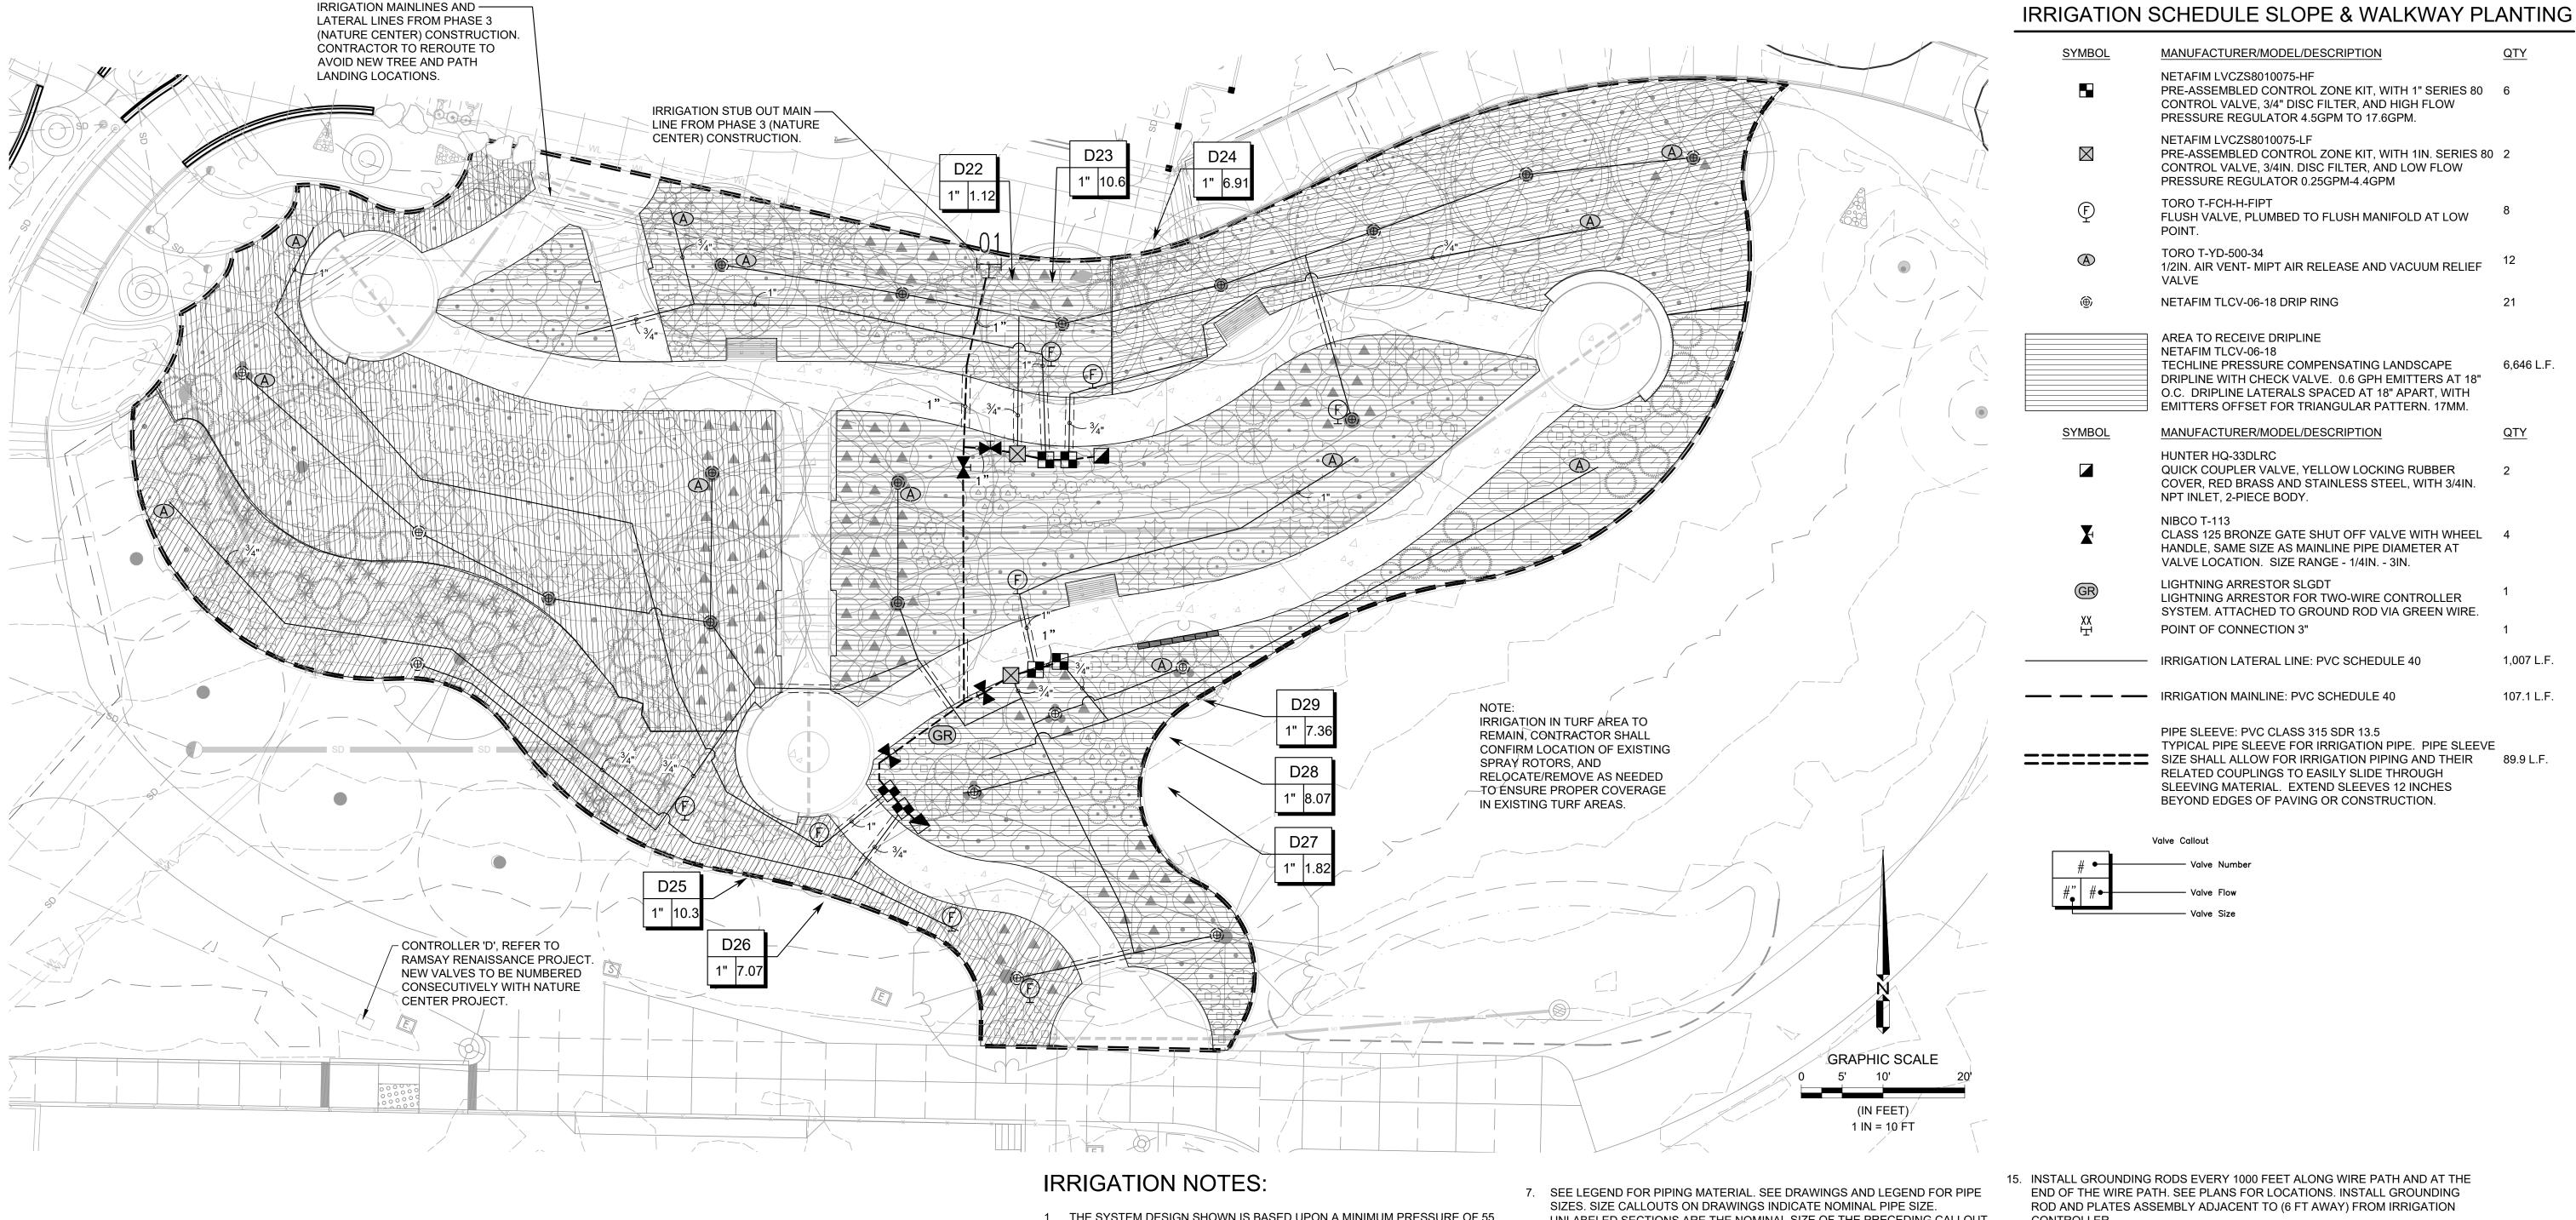
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DRAWING NO. PD-1 15 OF 19 SHEETS

DESIGNERS: EAS, SLB DRAWN BY: MCC

DATE: 7/9/2024

FOR REDUCED PLANS ORIGINAL SCALE IS IN INCHES FILE NAME: 1535-0007-IRRG.DWG Plot Date: 7/9/2024



- 1. THE SYSTEM DESIGN SHOWN IS BASED UPON A MINIMUM PRESSURE OF 55 PSI AT A MAXIMUM DISCHARGE OF 11 GPM. VERIFY PRESSURE AND FLOW ON SITE PRIOR TO CONSTRUCTION WORK AND REPORT ANY DISCREPANCIES TO THE OWNER'S REPRESENTATIVE.
- 2. ALL WORK SHALL CONFORM TO LOCAL AND STATE CODES AND ORDINANCES AND THE PLANS, SPECIFICATIONS, DETAILS AND NOTES FOR THIS PROJECT. READ THOROUGHLY AND BECOME FAMILIAR WITH THE SPECIFICATIONS AND 9. INSTALLATION DETAILS FOR THIS AND RELATED WORK PRIOR TO CONSTRUCTION.
- 3. THE CONTRACTOR SHALL VERIFY ALL EXISTING CONDITIONS, INCLUDING, BUT NOT LIMITED TO, UNDERGROUND UTILITIES AND STRUCTURES. COORDINATE ALL WORK WITH CIVIL, MECHANICAL, AND ELECTRICAL WORK AND TRADES TO MINIMIZE CONFLICTS. THE WORK INCLUDES THE RESPONSIBILITY FOR THE INSTALLATION OF IRRIGATION SLEEVING. CONTRACTOR SHALL COORDINATE SLEEVE INSTALLATION AND SEQUENCE HIS WORK WITH ALL WORK AND DISCIPLINES AS REQUIRED.
- 4. LAYOUT SHOWN IS DIAGRAMMATIC. IRRIGATION PIPING AND COMPONENTS MAY BE SHOWN OUTSIDE PLANTING AREAS FOR CLARITY. INSTALL IRRIGATION PIPING AND WIRING IN LANDSCAPED AREAS WHENEVER POSSIBLE. INSTALL IRRIGATION VALVES IN GROUND COVER OR SHRUB AREAS WHENEVER POSSIBLE. LOCATE IRRIGATION CONTROL AND QUICK COUPLING VALVES ADJACENT TO HARDSCAPE AREAS FOR EASY ACCESS. AVOID CONFLICTS BETWEEN THE IRRIGATION SYSTEM, PLANTING MATERIAL, AND ARCHITECTURAL FEATURES.
- DO NOT PROCEED WITH THE INSTALLATION OF THE SYSTEM WHEN IT IS EVIDENT THAT FIELD CONDITIONS OR DIFFERENCES EXIST THAT COULD NOT 13. THE IRRIGATION CONTROLLER PROVIDED PER THE NATORE CENTER HAVE BEEN CONSIDERED IN ENGINEERING OR IF DISCREPANCIES IN CONSTRUCTION DRAWINGS, DETAILS, NOTES AND SPECIFICATIONS ARE DISCOVERED. BRING ALL SUCH DIFFERING FIELD CONDITIONS AND DISCREPANCIES TO THE ATTENTION OF THE OWNER'S REPRESENTATIVE.
- IRRIGATION SYSTEM SHALL CONNECT TO THE EXISTING IRRIGATION SYSTEM THAT IS IN PLACE FROM PHASE 3 (NATURE CENTER) CONSTRUCTION. CONTRACTOR SHALL CONFIRM ALL EQUIPMENT IS IN PLACE AND OPERATIONAL PRIOR TO FINAL SYSTEM OPERATION.

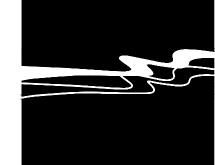
- UNLABELED SECTIONS ARE THE NOMINAL SIZE OF THE PRECEDING CALLOUT.
- 8. UNLESS OTHERWISE NOTED, TRENCHING DEPTHS FOR IRRIGATION SHALL BE 18" FOR MAINLINES AND 12" FOR LATERALS. DEPTH SHALL BE MEASURED

SUBSEQUENT CALLOUTS INDICATE CHANGE IN PIPE SIZE.

FROM THE TOP OF PIPE TO FINISHED SOIL LEVEL.

- INSTALL CONCRETE THRUST BLOCKS ON ALL MAINLINES THREE (3) INCHES AND LARGER IN DIAMETER IN ACCORDANCE WITH LOCAL CODES AND STANDARDS OR ASAE STANDARD S376.1.
- ALL MAINLINES, LATERALS, AND CONTROL WIRES UNDER PAVEMENT SHALL BE INSTALLED IN SCHEDULE 40 PVC SLEEVES. SLEEVES SHALL EXTEND 12" BEYOND EDGE OF PAVEMENT AND SHALL HAVE ENDS CLEARLY MARKED ABOVE GRADE DURING CONSTRUCTION.
- 11. PRIOR TO BACKFILLING, FLUSH AND TEST MAINS AND LATERALS. FLUSH MAINS BEFORE INSTALLING VALVES. FLUSH LATERALS BEFORE INSTALLING DRIP LINE. SUBJECT MAINS TO HYDROSTATIC PRESSURE OF 1.5 TIMES THE ANTICIPATED OPERATING PRESSURE (MIN. 100 PSI) FOR TWO HOURS. SUBJECT LATERALS TO HYDROSTATIC PRESSURE EQUAL TO ANTICIPATED OPERATING PRESSURE. ALL FLUSHING SHALL BE DONE IN THE PRESENCE OF THE ARCHITECT. BACKFILL WITH CLEAN MATERIAL FROM EXCAVATION. REMOVE ROCKS AND DEBRIS LARGER THAN 1" DIAMETER.
- 12. INSTALL QUICK COUPLING VALVE ASSEMBLIES AS SHOWN OR APPROXIMATELY 50 FEET ON CENTER FOR IRRIGATION AND HARDSCAPE WASHDOWN WATER.
- 14. INSTALL 14-2 MAXI-CABLE CONTROL WIRE FROM THE CONTROLLER TO EACH REMOTE CONTROL VALVE, VALVE DECODER. CONTROL WIRE TO BE INSTALLED IN 1¹/₄" PVC CLASS 315 SDR 13.5 SLEEVING. COIL THREE(3) FEET OF WIRE IN EACH VALVE OR SPLICE BOX. USE 3M DBY SPLICE KITS (OR APPROVED EQUAL) FOR ALL WIRE CONNECTIONS AND SPLICES. ALL WIRE SPLICES SHALL BE IN A 10" ROUND SPLICE BOX.

- 15. INSTALL GROUNDING RODS EVERY 1000 FEET ALONG WIRE PATH AND AT THE END OF THE WIRE PATH. SEE PLANS FOR LOCATIONS. INSTALL GROUNDING ROD AND PLATES ASSEMBLY ADJACENT TO (6 FT AWAY) FROM IRRIGATION CONTROLLER.
- 16. CONTRACTOR SHALL BE RESPONSIBLE FOR COMPLETE AND UNIFORM COVERAGE OF ALL PLANTED AREAS. ADJUST REMOTE CONTROL VALVE PRESSURE REGULATOR AND FLOW CONTROL TO BALANCE EACH LATERAL SYSTEM AND TO ENSURE PROPER VALVE CLOSURE TIME.
- 17. CONTRACTOR SHALL ADJUST DRIP EMITTER LOCATION(S) AND ADD EMITTERS AS REQUIRED TO ACCOMMODATE PLANT NEEDS.
- 18. INSTALL PLASTIC CHECK VALVES FOR EVERY 6-FT OF ELEVATION DROP IN DRIP VALVE ZONE.



<u>QTY</u>

21

6,646 L.F.

<u>QTY</u>


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DESIGNERS: EAS DRAWN BY: EAS DATE: 07/09/24 DRAWING NO.

FILE NAME: 1535-0007-IRRG.DWG Plot Date: 7/9/2024 ORIGINAL SCALE IS IN INCHES

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PLE NAME: 1535-0007-IRRG.DWG Plot Date: 7/9/2024 ORIGINAL SCALE IS IN INCHES
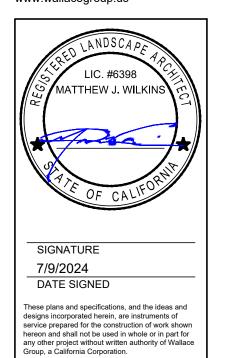
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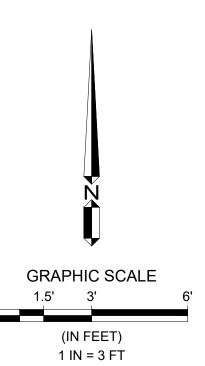
IRRIGATION PLANS (SHEET L10.1).

APPROXIMATE LOCATION — OF IRRIGATION MAINLINE PENETRATION THROUGH THE ROOF. CONFIRM WITH PHASE III, EXPLORATION CENTER PROJECT PLUMBING PLANS (SHEET P1.1). APPROXIMATE LOCATION OF — IRRIGATION MAINLINE IN BUILDING, INSTALLED PER PHASE III, NATURE CENTER PLANS. SEE SHEET P2.1 EXPLORATION CENTER PLAN SET. APPROXIMATE LOCATION OF — IRRIGATION VALVE BOX INSTALLED PER PHASE III, EXPLORATION CENTER PROJECT. CONFIRM WITH ARCHITECTURAL PLANS (SHEET A-103). APPROXIMATE LOCATION OF — GREEN ROOF IRRIGATION POINT OF CONNECTION INSTALLED PER PHASE III, EXPLORATION CENTER PROJECT. CONFIRM WITH

IRRIGATION SCHEDULE GREEN ROOF

SYMBOL	MANUFACTURER/MODEL/DESCRIPTION	QTY
	NETAFIM LVCZS8010075-LF PRE-ASSEMBLED CONTROL ZONE KIT, WITH 1IN. SERIES 80 CONTROL VALVE, 3/4IN. DISC FILTER, AND LOW FLOW PRESSURE REGULATOR 0.25GPM-4.4GPM	1
Ē	TORO T-FCH-H-FIPT FLUSH VALVE, PLUMBED TO FLUSH MANIFOLD AT LOW POINT.	1
(A)	TORO T-YD-500-34 1/2IN. AIR VENT- MIPT AIR RELEASE AND VACUUM RELIEF VALVE	1
	AREA TO RECEIVE DRIPLINE NETAFIM TLCV-06-18 TECHLINE PRESSURE COMPENSATING LANDSCAPE DRIPLINE WITH CHECK VALVE. 0.6 GPH EMITTERS AT 18" O.C. DRIPLINE LATERALS SPACED AT 18" APART, WITH EMITTERS OFFSET FOR TRIANGULAR PATTERN. 17MM.	519.4 L.F.
SYMBOL	MANUFACTURER/MODEL/DESCRIPTION	QTY
*	NIBCO T-113 CLASS 125 BRONZE GATE SHUT OFF VALVE WITH WHEEL HANDLE, SAME SIZE AS MAINLINE PIPE DIAMETER AT VALVE LOCATION. SIZE RANGE - 1/4IN 3IN.	1
FRI	EZ-FLO FERTILIZING SYSTEMS EZ001-CX ONE SYSTEM FEEDS ALL ZONES, DRIP OR SPRINKLER. USED FOR SMALLER COMMERCIAL LANDSCAPES, RESIDENTIAL, HOAFT.S, MODEL HOMES, AND GROWER APPLICATIONS. INSTALL DIRECTLY IN THE IRRIGATION SYSTEM MAIN LINE AFTER THE BACK FLOW PREVENTER. TANK CAPACITY: 1.5 G.	1
고 XX	POINT OF CONNECTION 3"	1
	IRRIGATION LATERAL LINE: PVC SCHEDULE 40	116.2 L.F.
	IRRIGATION MAINLINE: PVC SCHEDULE 40	8.1 L.F.
	IRRIGATION MAINLINE: PVC SCHEDULE 40 1" IRRIGATION LINE PROVIDED THROUGH BUILDING AS PART OF PHASE III NATURE CENTER PROJECT.	27.3 L.F.
	IRRIGATION MAINLINE: SCHEDULE 40 STD. STEEL PIPE	9.8 L.F.
=======	PIPE SLEEVE: PVC CLASS 315 SDR 13.5 TYPICAL PIPE SLEEVE FOR IRRIGATION PIPE. PIPE SLEEVE SIZE SHALL ALLOW FOR IRRIGATION PIPING AND THEIR RELATED COUPLINGS TO EASILY SLIDE THROUGH SLEEVING MATERIAL. EXTEND SLEEVES 12 INCHES BEYOND EDGES OF PAVING OR CONSTRUCTION.	3.1 L.F.
	/alve Callout	

NOTE:
DRIP IRRIGATION SYSTEM PER DRIP SYSTEM DETAILS. WATERPROOF SYSTEM AND
DRAINAGE SYSTEMS ARE PROVIDED UNDER ARCHITECTURAL SCOPE.



JOB #: 1535-0007

DESIGNERS: EAS

DRAWN BY: EAS

DATE: 07/09/24

DRAWING NO.


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ISAY PARK GREEN INFRASTRUCTURE

TREE RING LAYOUT

LEGEND:

(1) FINISH GRADE

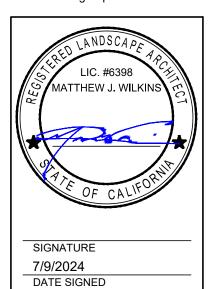(3) VALVE ID TAG

REGULATOR)

(7) PVC SCH 80 FEMALE

AS REQUIRED)

(10) PVC SCH 80 TEE OR ELL

(12) 1/2" WIRE CLOTH GOPHER

(13) PVC SCH 80 STREET ELL

(14) MANUEL FLUSH POINT

1/2" = 1'-0"

(1) 1" GALVANIZED STEEL PIPE FROM

LEGEND:

SCREEN, WRAP UP ALL

DRIPLINE

(8) PVC SCH 80 ELL

(11) PVC MAINLINE

2 JUMBO VALVE BOX WITH

4 30-INCH LENGTH OF COILED

(5) DRIP KIT (INCLUDES VALVE, FILTER & PRESSURE

6 PVC SUPPLY HEADER TO

ADAPTER OR REDUCER

(9) PVC SCH 80 NIPPLE (LENGTH

8' CIRCUMFERENCE

4' CIRCUMFERENCE

1) 10" DIAMETER VALVE BOX. HEAT BRAND "QCV" ON LID WITH 2" HIGH LETTERS

(3) 10" DIAMETER VALVE BOX

(2) FINISHED GRADE

(4) FLUSH TO GRADE AT

(5) 1" ABOVE GRADE AT

(6) QUICK COUPLER AS

(7) GALVANIZED RISER AND

(8) FOUR COMMON BRICKS

ELBOW, QC INLET SIZE

AS SUPPORT UNDER BOX

GOPHER SCREEN, WRAP

(12) 60 LB CONCRETE TORQUE

32 8406.43-03

SPECIFIED

(9) 1/2" WIRE CLOTH

(11) PVC MALE ADAPTER

UP SIDES

(10) MAIN LINE

BLOCK

QUICK COUPLING VALVE IN BOX ASSEMBLY

2 VALVE BOX & COVER - PROVIDED WITH EXPLORATION CENTER, PHASE III

(3) PROPORTIONING CAP W/FEED ADJUSTMENT KNOB

(5) EZ-FLO IN-LINE FERTIGATION SYSTEM TANK

PROPORTIONING CAP & COUPLING

DIRECTION ARROW

(14) PRESSURE RELIEF VALVE

(4) EZ-FLO SHUT OFF VALVES W/ DISCONNECT WASHERS

(7) WATER IN - CONNECT BLACK TUBE TO BLUE CONNECTIONS ON

(11) BALL VALVE COUPLING CONNECTOR - INSTALL ACCORDING TO WATER FLOW

1 1/2" = 1'-0"

(1) FINISHED GRADE

CONSTRUCTION MANAGEMENT LANDSCAPE ARCHITECTURE MECHANICAL ENGINEERING PLANNING PUBLIC WORKS ADMINISTRATION SURVEYING / GIS SOLUTIONS

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WATER RESOURCES



DATE SIGNED

WALLACE GROUP® CIVIL AND TRANSPORTATION ENGINEERING

SAN LUIS OBISPO, CA 93401 T 805 544-4011 F 805 544-4294

SIGNATURE

These plans and specifications, and the ideas and designs incorporated herein, are instruments of service prepared for the construction of work shown

7/9/2024

RUCTURE WATSONVILLE EN INFRAS GREI OF CITY

DESIGNERS: EAS DRAWN BY: EAS DATE: 07/09/24 DRAWING NO. ID-1

18 OF 19 SHEETS

LEGEND:

- 1) 10"X15" RECTANGULAR BOX WITH 6" EXTENSION
- (2) SET BOX FLUSH TO GRADE
- (3) ISOLATION BALL VALVE AS SPECIFIED, SAME SIZE AS MAIN LINE
- (4) SCHEDULE 80 THREADED NIPPLE AS REQUIRED
- (5) ADAPTER
- 6) PVC MAIN LINE
- 7) 1/2" WIRE CLOTH GOPHER SCREEN, WRAP UP SIDES
- (8) TWO 6X2X16 CONCRETE BLOCK CAPS, ONE ON EACH SIDE

BRASS BALL ISOLATION VALVE

32 8406.33-02

1 1/2" = 1'-0"

ROOT WATERING SYSTEM 32 8403.53-17

BAL

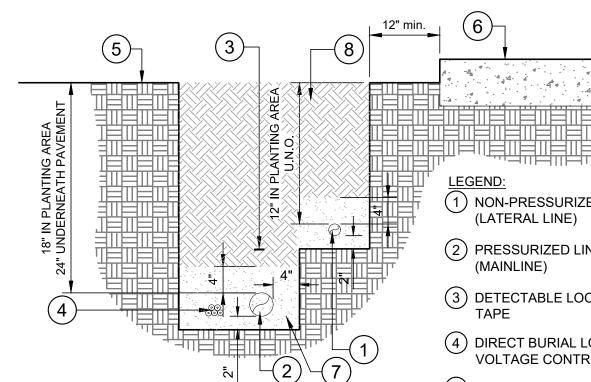
(1) BUBBLER HEAD, PLACE INSIDE PERFORATED PIPE UNDER GRATE CAP

4) FILL TUBE WITH ROUNDED DRAIN ROCK TO JUST BELOW BUBBLER

(5) THREADED SCH 80 RISER, LENGTH AS REQUIRED

(7) TREE PLANTING AS INDICATED ON PLANTING DETAILS

(3) LOCKING GRATE CAP. TOP OF CAP SHALL BE A MINIMUM OF 1/2 INCH ABOVE




- PIPE SIZE AND TYPE. B. DIRECT BURIAL CONTROL WIRES SHALL BE INSTALLED IN SCH. 40 PVC SLEEVE UNDER PAVEMENT.
- INCHES (6") ABOVE THE ENTIRE MAINLINE RUN.

IN-LINE FERTIGATION

EZ-FLO FERTILIZING SYSTEM MODEL # - EZ001-CX 1.5 GAL CAPACITY WITH THE EZ-FLO SYSTEM.

6 FERTILIZER OUT- CONNECT CLEAR TUBE TO GREEN CONNECTIONS ON PROPORTIONING CAP & COUPLING 8) 1/4" TUBING CLAMP - BOTH GREEN & BLUE COUPLING TUBING CONNECTIONS 9 APPROVED BACKFILL (10) PVC MAINLINE TO VALVE MANIFOLD (12) PEA GRAVEL (1 CU FT) (13) MAIN LINE

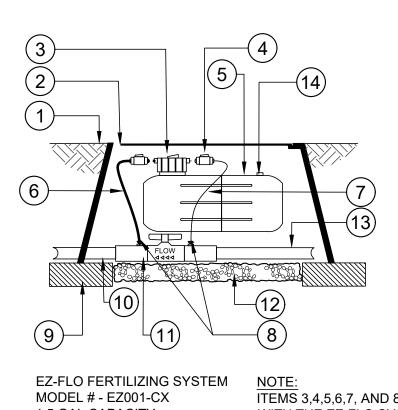ITEMS 3,4,5,6,7, AND 8 ARE INCLUDED



1) NON-PRESSURIZED LINE (2) PRESSURIZED LINE (3) DETECTABLE LOCATOR (4) DIRECT BURIAL LOW VOLTAGE CONTROL WIRES 5 FINISHED GRADE (6) PAVEMENT (7) SAND BACKFILL, MATERIAL

A. SEE IRRIGATION LEGEND FOR MAINLINE AND LATERAL LINE

- C. 2-WIRE IRRIGATION WIRE SHALL BE INSTALLED IN SCH. 40 ELECTRICAL CONDUIT.
- D. DETECTABLE LOCATOR TAPE SHALL BE LOCATED SIX

FX-IR-FX-AUXEQ-08

FREE FROM ALL ROCK AND

DEBRIS GREATER THAN

ONE HALF INCH. 6" ABOVE

AND 6" BELOW PRESSURE

8 BACKFILL MATERIAL, FREE FROM ALL ROCK AND

DEBRIS LARGER THAN

SUPPLY LINE

1-INCH

IRRIGATION TRENCHING $1 \frac{1}{2} = 1'-0''$

DRIP ZONE KIT IN VALVE BOX 328413.46-07

LEGEND:

1) SCH 40 PVC LATERAL LINE

328413.24-01

2 DRIP LINE

(3) INSERT ADAPTER

(4) INSERT CROSS

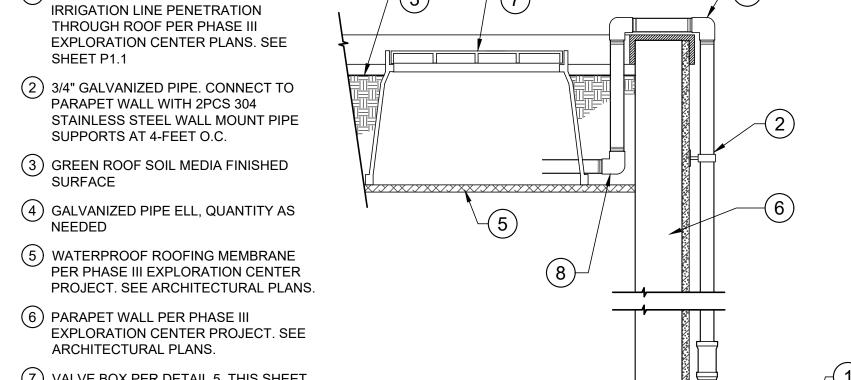
(5) INSERT TEE

2 ROOT WATERING TUBE


FINISHED GRADE

CONNECTION

(6) THREAD/SLIP ELL



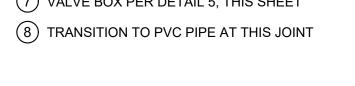(7) VALVE BOX PER DETAIL 5, THIS SHEET





Attachment 3 Page 18 of 19

1. INTERCEPT EXISTING AND EXTEND 1" CONDUIT STUBBED OUT FROM

PEDESTRIAN FIXTURE AS PART OF NATURE CENTER PROJECT. EXTEND

GENERAL NOTES

- CODE COMPLIANCE: ALL WORK SHALL CONFORM TO AND BE PERFORMED IN ACCORDANCE WITH CODES, STANDARDS, AND ORDINANCES AS SET FORTH BY THE AUTHORITIES HAVING JURISDICTION AND THEIR LATEST ADOPTED EDITIONS (IN EFFECT AT TIME CONSTRUCTION) OF THE FOLLOWING PUBLICATIONS:
- A. CALIFORNIA CODE OF REGULATIONS TITLE 24; INCLUDES 2022 CALIFORNIA ELECTRICAL CODE, 2022 CALIFORNIA FIRE CODE, 2022 CALIFORNIA BUILDING CODE, ETC. WITH LOCAL AMENDMENTS AS APPLICABLE.
- B. GENERATOR: 2022 CALIFORNIA FIRE CODE CHAPTER 6, SECTION 604 AND NFPA 110 AND 111. COMPLIANCE WITH UL-2200 IS REQUIRED
- C. AMERICANS WITH DISABILITIES ACT (ADA).
- 2. SAFETY: THE ELECTRICAL CONTRACTOR IS RESPONSIBLE TO MAINTAIN ALL EQUIPMENT IN A SAFE AND RESPONSIBLE MANNER. KEEP DEAD FRONT EQUIPMENT IN PLACE WHILE EQUIPMENT IS ENERGIZED. CONDUCT ALL CONSTRUCTION OPERATIONS IN A SAFE MANNER FOR EMPLOYEES AS WELL AS OTHER WORKPERSONS OR ANYONE VISITING THE JOB SITE. PROVIDE BARRIERS, FLAGS, TAPE, ETC. AS REQUIRED FOR SAFETY. THE CONTRACTOR SHALL HOLD ALL PARTIES HARMLESS OF NEGLIGENT SAFETY PRACTICES, WHICH MAY CAUSE INJURY TO OTHERS ON OR NEAR THE JOB SITE.
- 3. ALL CONDUCTORS SHALL BE COPPER WITH TYPE THHN/THWN INSULATION UNLESS OTHERWISE NOTED.

ABBREVIATIONS

A AMPERE AF AMP FUSE RATING AFF ABOVE FINISH FLOOR AFG ABOVE FINISH GRADE

MC MECHANICAL CONTRACTOR AIC AMPERES INTERRUPT CAPACITY AS AMP SWITCH RATING BFG BELOW FINISH GRADE CB CIRCUIT BREAKER CEC CA. ELECTRICAL CODE

CKT CIRCUIT C CONDUIT C.O. CONDUIT ONLY (E) EXISTING EC ELECTRICAL CONTRACTOR

EF-# EXHAUST FAN (EXN) (E) IN (N) LOCATION (EXR) (E) TO BE (R) (F) FUTURE FA FIRE ALARM FACP FIRE ALARM CONTROL PANEL

G GROUNDING CONDUCTOR GC GENERAL CONTRACTOR GND GROUND

#4 BARE CU GROUND CONDUCTOR

GROUND ROD IN PULL BOX.

NEW ABOVE GROUND/SURFACE CONDUIT/CIRCUIT

- - - NEW UNDERGROUND CONDUIT/CIRCUIT —— EXISTING CONDUIT/CIRCUIT

(TBR) TO BE REMOVED TYP TYPICAL UC UNDERCABINET UG UNDERGROUND

(N) NEW

P POLE

GRS GALVANIZED RIGID STEEL

GWS GANGED WITH SWITCH

MCB MAIN CIRCUIT BREAKER

MTTB MAIN TELEPHONE TERMINAL BOARD

MLO MAIN LUGS ONLY MSB MAIN SWITCHBOARD

NIC NOT IN CONTRACT

NL NIGHT LIGHT

PV PHOTOVOLTAIC

(R) RELOCATE(D)

UON UNLESS OTHERWISE NOTED

WP WEATHERPROOF (NEMA 3R)

IG ISOLATED GROUND

LTG LIGHTING

V VOLT VA VOLT AMPERES GFI GROUND FAULT CKT INTERRUPTER W WATT, WIRE

LEGEND

GASKET COVER

BASE COVER WITH

DRY PACK BELOW

(3)#3 REBAR TIES WITHIN

TOP 5" OF CONCRETE, SEE

3000 PSI CONCRETE BASE AT

28 DAYS. POUR IN NATURALLY

COPACTED EARTH HOLE FREE

OF LOOSE DIRT AND DEBRIS.

GALVANIZED ANCHOR BOLT.

- 3" MINIMUM BETWEEN STEEL AND BELOW GRADE

OUTSIDE OF CONCRETE

- #5 VERTICAL REBAR,

-#3 REBAR TIES AT 12" ON CENTER VERTICALLY, TYPICAL, SEE NOTE 3.

STANDARD 180° J-HOOK AT BOTTOM OF VERTICAL REBAR, TYPICAL OF 4

PROVIDED BY POLE

MANUFACTURER. TYPICAL OF 4

BASEPLATE

NOTE 3.

NOTES:

MANUFACTURER.

- - - EXISTING UNDERGROUND CONDUIT/CIRCUIT PULL BOX, HANDHOLE, JUNCTION BOX

LIGHTING AND POLE SCHEDULE

"LIGHTING" PULL

ADJACENT TO POLE

TYPE	SYMBOL	MANUFACTURER	CATALOG NO.	VOLTAGE	MAX. VA.	LAMPING	MOUNTING	DESCRIPTION
S5	••	POLE:	HEAD: PUREFORM 26 P26-500-NW-G2-AR-5- UNV-BL-IMRI3-MGY POLE: RSP15-4.0-11-GRY- DM10-BC-LAB	120-277 VAC	75	4000K LED		AREA LIGHT WITH INTEGRAL MOTION SENSOR. MOUNTED TO 15FT TALL 4" STRAIGHT ROUND POLE. FIXTURES TO MATCH NATURE CENTER PEDESTRIAN LIGHTS. NO SUBSTITUTIONS.

1" CHAMFER AT 45° ——

3/4" POWER

FINISH GRADE ·

GALV. ANCHOR BOLTS & TEMPLATE PROVIDE BY POLE

CONDUIT SHALL BE 3/4" MINIMUM SIZE AND MINIMUM 18" BELOW TIES SHALL HAVE AT EACH END A 135 DEGREE HOOK BEND WITH A SIX-BAR DIAMETER, BUT NOT LESS THAN 3 INCH, EXTENSION THAT ENGAGES THE LONGITUDINAL REINFORCEMENT AND PROJECTS INTO THE INTERIOR OF THE STIRRUP OR HOOP. PROVIDE 5/8" X 8FT CU GROUND ROD BURIED IN EARTH WITHIN 5 FT OF POLE. ATTACH TO POLE'S GROUND LUG WITH #8 BARE CU

"LIGHTING", "PG&E", "TELE", "ELECTRIC", OR "SIGNAL" AS FINISHED GRADE PRECAST CONCRETE BOX. SIZE PER PLANS.

- BRANCH CIRCUIT, FEEDER

GREEN INFRASTRUCTURE WATSONVILLE ОЕ CITY

DESIGNERS: OTTO DRAWN BY: OTTO DATE: 6/19/2024 DRAWING NO. E-1

OF SHEETS

2. 1"C - 2#10 THWN & 1#10 GND. TYPICAL. NEW AREA LIGHT PER FIXTURE SCHEDULE. SEE DETAIL 3. TYPICAL.

SITE ELECTRICAL PLAN

X REFERENCE NOTES

2#10 THWN & 1#10 GND TO NEW LIGHTS.

TYPICAL LIGHT POLE MOUNTING DETAIL

TYPICAL AT GRADE PULL BOX DETAIL

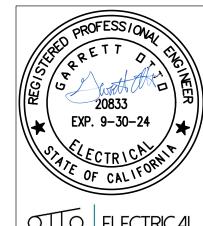
TYPICAL BRANCH CIRCUIT **TRENCH**

Attachment 3 Page 19 of 19

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